



- ALL DIMENSIONS ARE IN MILLIMETRES OR METRES UNLESS OTHERWISE SPECIFIED.
- SERVICES TO EXTEND 1.5m INSIDE PROPERTY LINE.
- UNDER NO CIRCUMSTANCE SHALL SERVICES CROSS ONE ANOTHER.
- ALL UNDERGROUND SERVICE CABLES TO BE PLACED MINIMUM 1.0m BELOW FINISHED GRADE AT LOTS.
- 5. SHUT-OFF VALVES AND SEWER CLEANOUTS TO BE PLACED ON PROPERTY LINE.


NO.	REVISION	APR'D	DATE
1	REVISED WATER SERVICE		JUL/15
2	2023 UPDATE		DEC/23

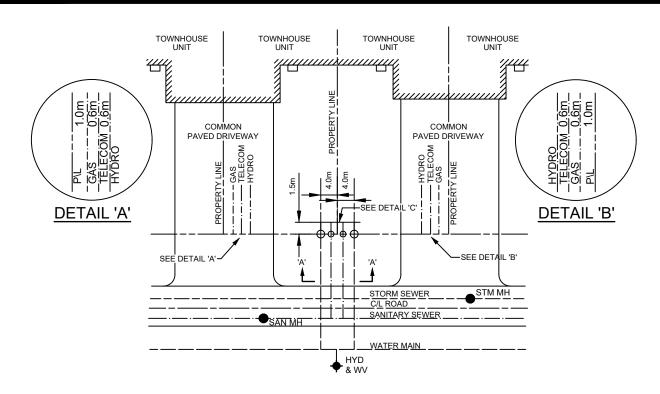

TOWNSHIP OF SEVERN	APR'D:	DATE:	2012
TOWNSHIP OF SEVERN	DRAWN:	SCALE:	NTS
SERVICE LOCATION - SINGLE FAMILY & SEMI-DETACHED RESIDENTIAL	STD. No.	101	



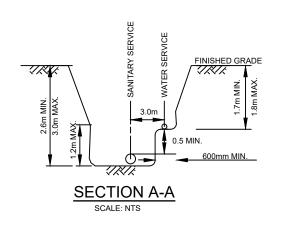

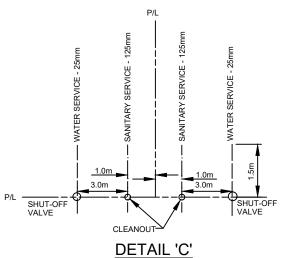


SCALE: NTS


- ALL DIMENSIONS ARE IN MILLIMETRES OR METRES UNLESS OTHERWISE SPECIFIED.
- SERVICES TO EXTEND 1.5m INSIDE PROPERTY LINE.
- UNDER NO CIRCUMSTANCE SHALL SERVICES CROSS ONE ANOTHER.
- ALL UNDERGROUND SERVICE CABLES TO BE PLACED MINIMUM 1.0m BELOW FINISHED GRADE AT LOTS.
- 5. SHUT-OFF VALVES AND SEWER CLEANOUTS TO BE PLACED ON PROPERTY LINE.

NO.	REVISION	APR'D	DATE
1	REVISED WATER SERVICE		JUL/15
2	2023 UPDATE & RENUMBERED		DEC/23

	TOWNSHIP OF SEVERN	APR'D:	DATE:	2012
	TOWNSHIP OF SEVERN	DRAWN:	SCALE:	NTS
SEVERN	SERVICE LOCATION TOWNHOUSE UNITS	STD. No.	102	

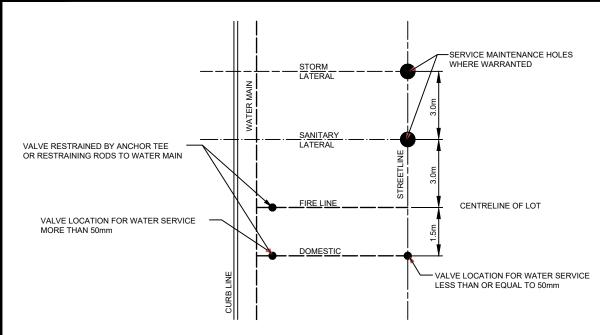

### SHORT SIDE CONNECTION

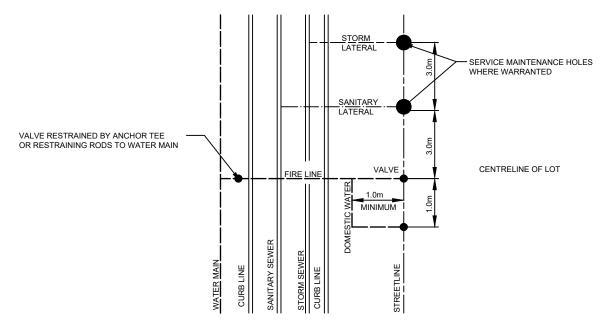


# LONG SIDE CONNECTION

- ALL DIMENSIONS ARE IN METRES UNLESS OTHERWISE SPECIFIED.
- 2. SERVICE LOCATIONS TO BE CONFIRMED WITH THE TOWNSHIP.


NO.	REVISION	APR'D	DATE
1	2023 UPDATE & RENUMBERED		DEC/23

— Township of — SEVERN	

TOWNSHIP OF SEVERN	APR'D:	DATE:	2012
TOWNSHIP OF SEVERN	DRAWN:	SCALE:	NTS
SERVICE LOCATION - COMMERCIAL, INDUSTRIAL AND MULTI-RESIDENTIAL	STD. No.	103	

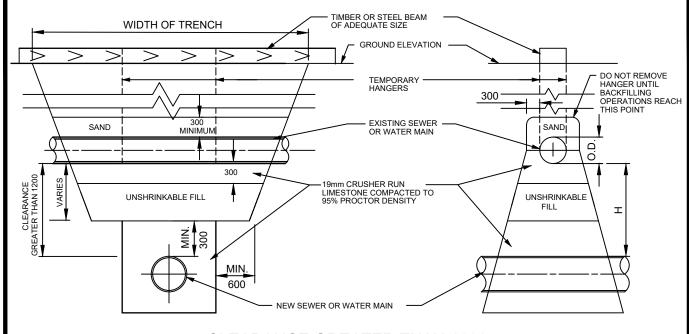

### **CLEARANCE GREATER THAN 1200**

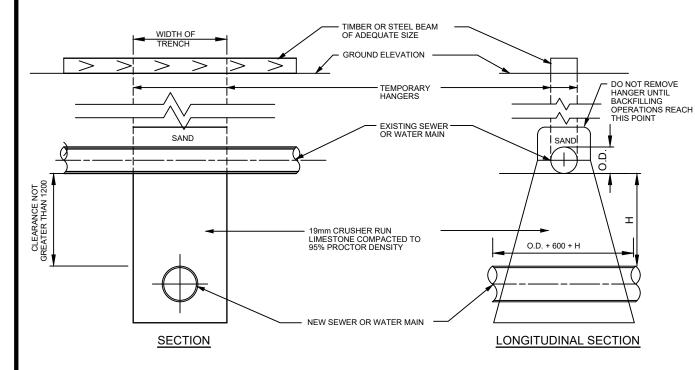


# **CLEARANCE NOT GREATER THAN 1200**

- 1. ALL DIMENSIONS ARE IN MILLIMETRES UNLESS OTHERWISE SPECIFIED.
- 2. THIS DETAIL TO BE USED IN DRY STABLE CONDITIONS ONLY.


NO.	REVISION	APR'D	DATE
1	2023 UPDATE & RENUMBERED		DEC/23

	TOWNSHIP OF SEVERN	APR'D:	DATE:	2012
	TOWNSHIP OF SEVERN	DRAWN:	SCALE:	NTS
SEVERN	SUPPORTS FOR WATER MAINS AND SEWERS CROSSING NEW TRENCHES	STD. No.	104	

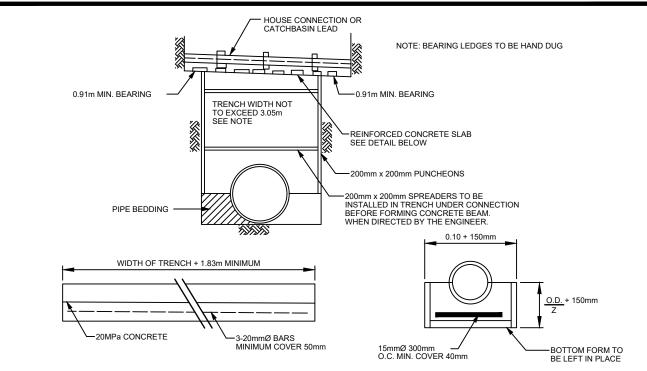

# REINFORCED CONCRETE SUPPORT FOR HOUSE CONNECTIONS AND CATCHBASIN LEADS WHEN WIDTH OF TRENCH EXCEEDS 1.52m BUT LESS THAN 3.05m

NOTE: WHEN WIDTH OF TRENCH EXCEEDS 3.05m METHOD OF SUPPORTING HOUSE CONNECTIONS AND CATCHBASIN LEADS WILL BE AS DIRECTED BY THE ENGINEER.

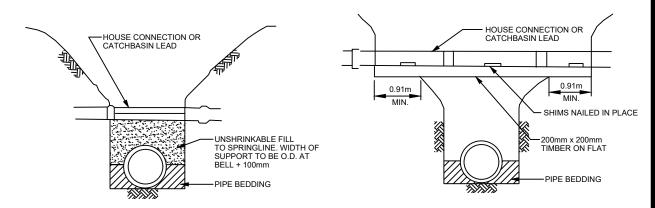


# SUPPORT FOR CONNECTION CROSSING TRENCH WHEN WIDTH OF TRENCH IS LESS THAN 1.52m

- 1. ALL DIMENSIONS ARE IN MILLIMETRES OR METRES UNLESS OTHERWISE SPECIFIED.
- WHERE HOUSE CONNECTIONS OR CATCHBASIN LEADS CROSS A SEWER TRENCH, THEY WILL BE SUPPORTED ON A NEW 20mm x 200mm TIMBER WHICH HAS A MINIMUM BEARING OF 0.91M AT EACH END ON UNDISTURBED GROUND. CONNECTION MUST BE PROPERLY SHIMMED OR BEDDED ON 20MPa CONCRETE FILL TO SPRINGLINE AS PER DETAILS.
- 3. TO BE USED WHEN INSTALLING SEWER OR WATERMAIN ON EXISTING R.O.W.
- 4. FOR ALL CROSSING OF GAS MAINS, CONTRACTOR TO CONTACT GAS COMPANY FOR LOCATES AND INSPECTIONS.


NO.	REVISION	APR'D	DATE
1	2023 UPDATE & RENUMBERED		DEC/23

	TOWNSHIP OF SEVERN
SEVERN	SUPPORTS FOR HOUSE CONNECTIONS AND CATCH BASIN LEADS

DRAWN: SCALE: NTS	SCALE: NTS
S   0.55 N   40.5	GOVEET. INTO
_	367.122. 1476

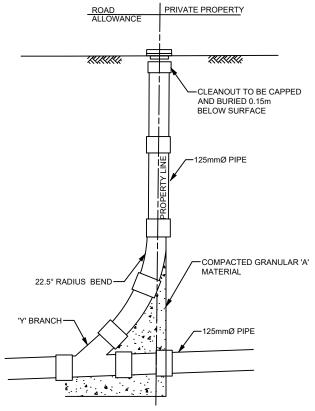

### SURFACE CLEANOUT

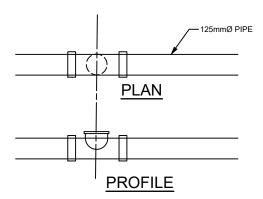



### **RUNNING CLEANOUT**


- 1. ALL DIMENSIONS ARE IN MILLIMETRES OR METRES UNLESS OTHERWISE SPECIFIED.
- 2. ALL FITTINGS TO BE APPROVED PVC OR EQUIVALENT.
- 3. CLEANOUTS ARE NOT TO BE LOCATED IN A DRIVEWAY.
- 4. CONCRETE CRADLE SHALL NOT BE USED FOR P.V.C. PIPE.
- SANITARY SEWER CLEANOUTS SHALL BE PLACED WHERE LATERAL SERVICES EXCEED 30m IN LENGTH WITHIN THE PUBLIC R.O.W.
- 6. WHERE PARTIAL BASEMENTS ARE CONSTRUCTED FOR DEVELOPMENT PROJECTS, CLEANOUTS SHALL BE PLACED 3.0 METRES FROM THE BUILDING ENVELOPE.
- 7. CLEANOUTS SHALL NOT BE PLACED IN REGISTERED EASEMENTS.

NO.	REVISION	APR'D	DATE
1	2023 UPDATE & RENUMBERED		DEC/23

	TOWNSHIP OF SEVERN	APR'D:	DATE: 2012
	TOWNSHIP OF SEVERIN	DRAWN:	SCALE: NTS
SEVERN	SANITARY SEWER CLEANOUTS	STD. No.	106

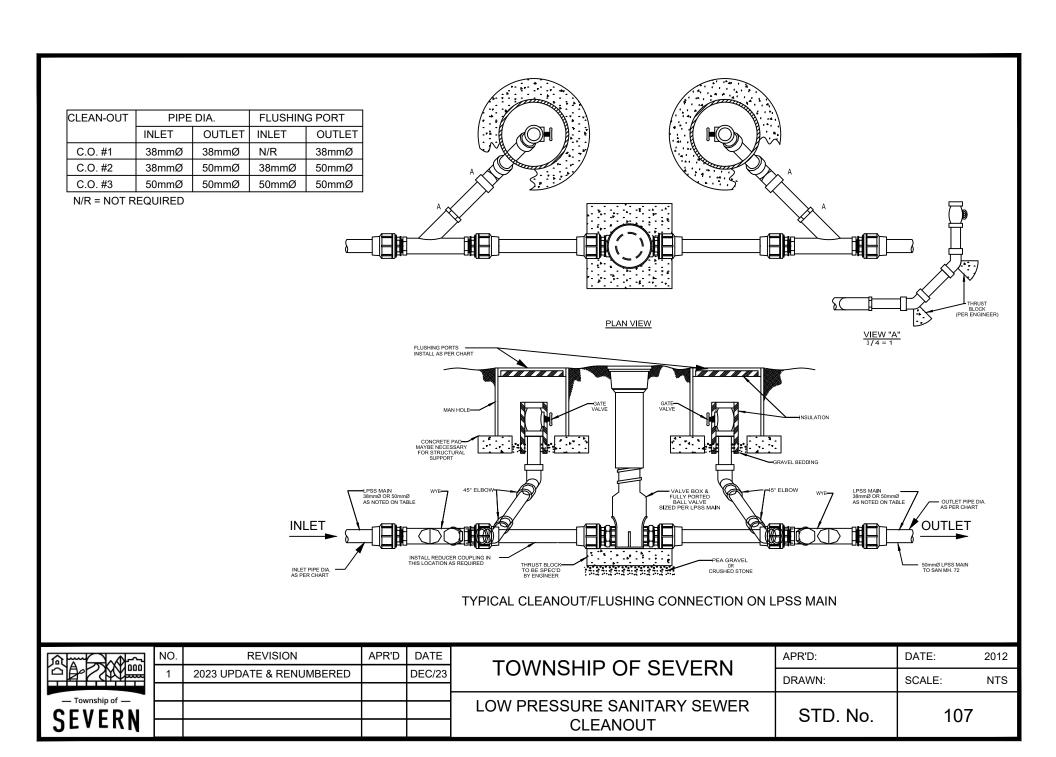


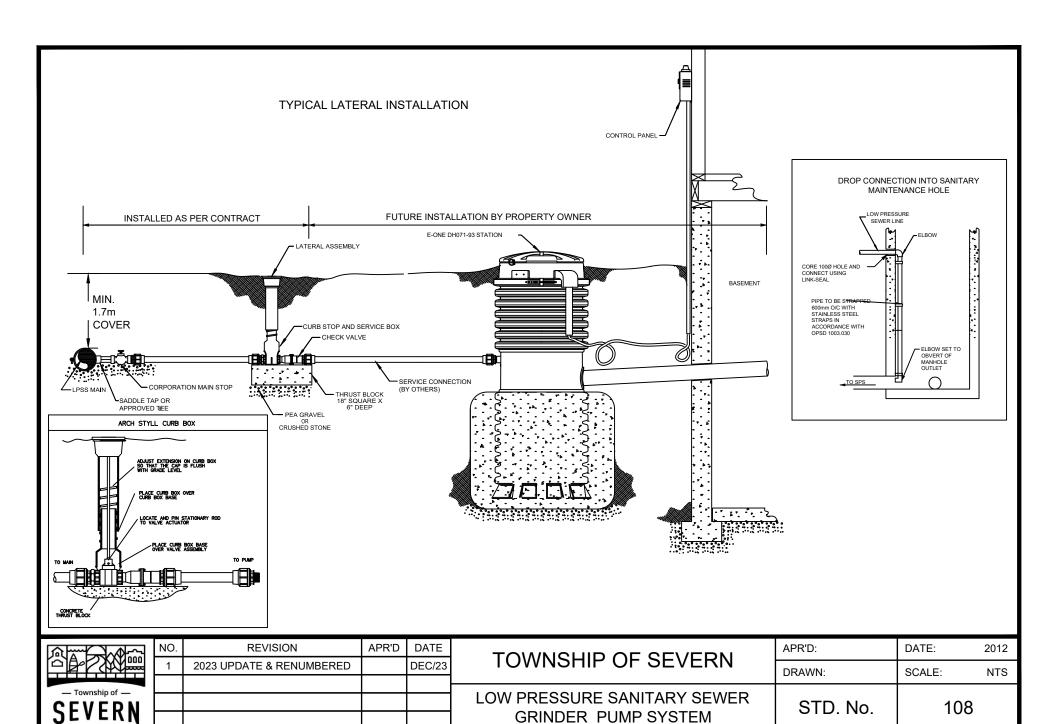

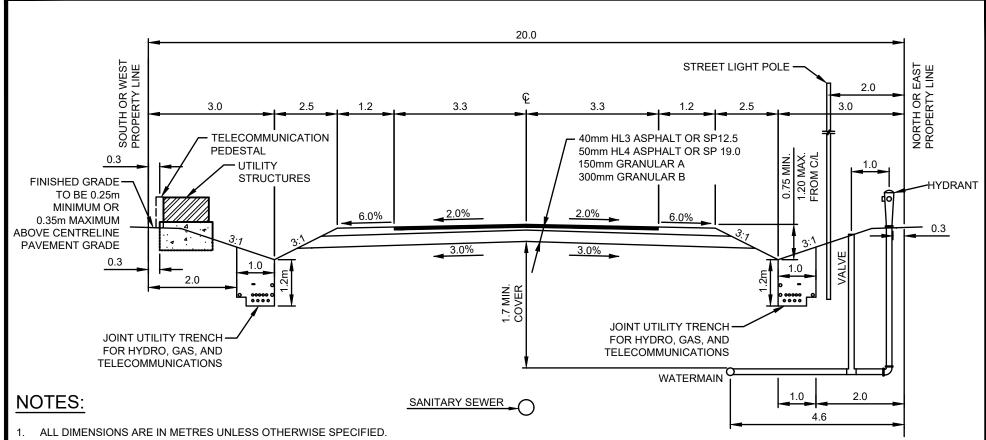


- MINIMUM PAVEMENT AND ROAD STRUCTURE DESIGN AS PER TOWNSHIP OF SEVERN ENGINEERING CRITERIA OR AS PER GEOTECHNICAL INVESTIGATION RECOMMENDATION.
- 3. DITCH GRADE TO BE MIN. 0.5%, MAX. 6.0% AND RESTORED WITH 150mm TOPSOIL & SOD.
- 4. ALL SERVICE LOCATIONS SHOWN ARE FOR GUIDELINE PURPOSES ONLY AND MAY DEVIATE AS PER THE DIRECTION OF THE TOWNSHIP WHEN STANDARD LOCATION CANNOT BE ACHIEVED.
- 5. ALL WATER CURB STOPS TO BE PLACED ON STREETLINE.
- 6. A 3.0 m WIDE PLATFORM AREA SHALL BE CONSTRUCTED FOR EACH FIRE HYDRANT. THE MINIMUM CULVERT LENGTH SHALL BE 7.0 m AND THE MINIMUM DIAMETER SHALL BE 300mm. PLATFORM AREAS SHALL BE RESTORED WITH 100mm TOPSOIL AND SOD.
- 7. SEE JOINT UTILITY TRENCH STANDARD DRAWING FOR 4 PARTY DETAILS. WHERE JOINT UTILITY TRENCH IS NOT USED, GAS IS TO BE 0.6m OFFSET FROM PROPERTY LINE, TELECOMMUNICATIONS IS TO BE 1.2m OFFSET FROM PROPERTY LINE. AND HYDRO IS TO BE 2.0m OFFSET FROM PROPERTY LINE.
- 8. ALL HOUSE SERVICES TO BE MINIMUM 0.76m BELOW DITCH GRADE AND INSTALLED AS REQUIRED.

	NO.	REVISION	APR'D	DATE	TOWNSHIP OF CEVEDN	APR'D:	DATE:	2012
	1	2023 UPDATE		DEC/23	TOWNSHIP OF SEVERN	DRAWN:	SCALE:	NTS
Township of — SEVERN					SEMI-URBAN LOCAL ROAD (OPEN DITCH) 20.0m ROAD ALLOWANCE 6.6m ASPHALT	STD. No.	201	

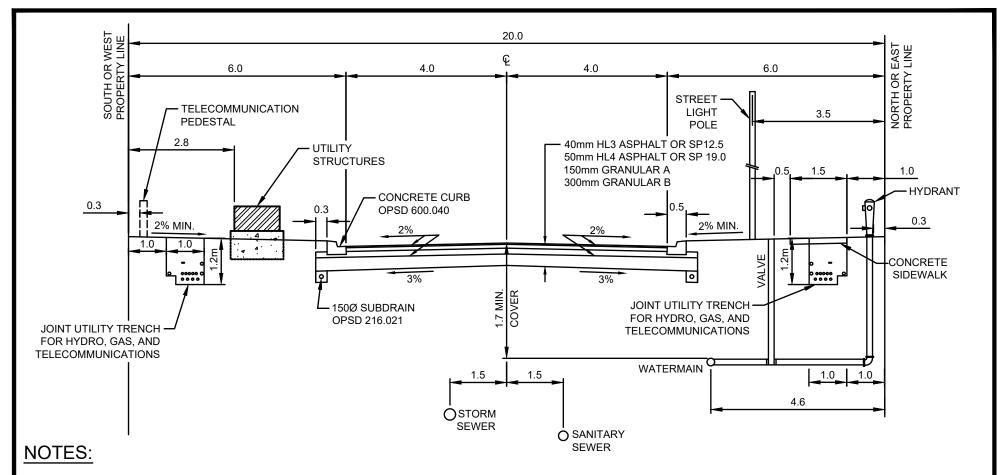


- 1. ALL DIMENSIONS ARE IN METRES UNLESS OTHERWISE SPECIFIED.
- 2. MINIMUM PAVEMENT AND ROAD STRUCTURE DESIGN AS PER TOWNSHIP OF SEVERN ENGINEERING CRITERIA OR AS PER GEOTECHNICAL INVESTIGATION RECOMMENDATION.
- 3. ALL SERVICE LOCATIONS SHOWN ARE FOR GUIDELINE PURPOSES ONLY AND MAY DEVIATE AS PER THE DIRECTION OF THE TOWNSHIP WHEN STANDARD LOCATION CANNOT BE ACHIEVED.
- 4. WHERE ONE SIDEWALK IS CONSTRUCTED IT SHALL BE ON THE NORTH AND EAST SIDE OF THE ROAD.
- 5. ALL WATER CURB STOPS TO BE PLACED ON STREETLINE.
- 6. BOULEVARD TO BE RESTORED WITH 150mm TOPSOIL & SOD.
- 7. SEE JOINT UTILITY TRENCH STANDARD DRAWING FOR 4 PARTY DETAILS.

	NO.	REVISION	APR'D	DATE	TOWNSHIP OF OF VEDNI	APR'D:	DATE:	2012
	1	2023 UPDATE & RENUMBERED		DEC/23	TOWNSHIP OF SEVERN	DRAWN:	SCALE:	NTS
Township of —					LOCAL RESIDENTIAL ROAD 20.0m ROAD ALLOWANCE 8.0m ASPHALT	STD. No.	202	

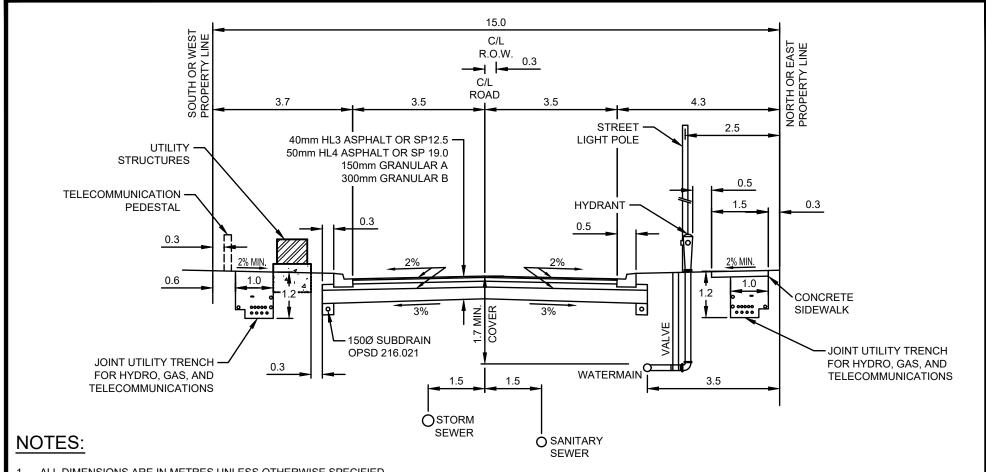


- ALL DIMENSIONS ARE IN METRES UNLESS OTHERWISE SPECIFIED.
- 2. MINIMUM PAVEMENT AND ROAD STRUCTURE DESIGN AS PER TOWNSHIP OF SEVERN ENGINEERING CRITERIA OR AS PER GEOTECHNICAL INVESTIGATION RECOMMENDATION.
- ALL SERVICE LOCATIONS SHOWN ARE FOR GUIDELINE PURPOSES ONLY AND MAY DEVIATE AS PER THE DIRECTION OF THE TOWNSHIP WHEN STANDARD LOCATION CANNOT BE ACHIEVED.
- ALL WATER CURB STOPS TO BE PLACED ON STREETLINE.
- BOULEVARD TO BE RESTORED WITH 150mm TOPSOIL & SOD.
- SEE JOINT UTILITY TRENCH STANDARD DRAWING FOR 4 PARTY DETAILS.
- STANDARD TOWNSHIP OFFSETS DO NOT APPLY IN THIS SCENARIO.

ı		NO.	REVISION	APR'D	DATE	TOWNSHIP OF CEVEDN	APR'D:	DATE:	2023
ı		1	2023 UPDATE		DEC/23	TOWNSHIP OF SEVERN	DRAWN:	SCALE:	NTS
ı	— Township of —					URBAN LOCAL RESIDENTIAL ROAD			
ı	SEVERN					15.0m ROAD ALLOWANCE	STD. No.	203	
	2 LA LIVIA					7.0m ASPHALT	3.2.110.	200	

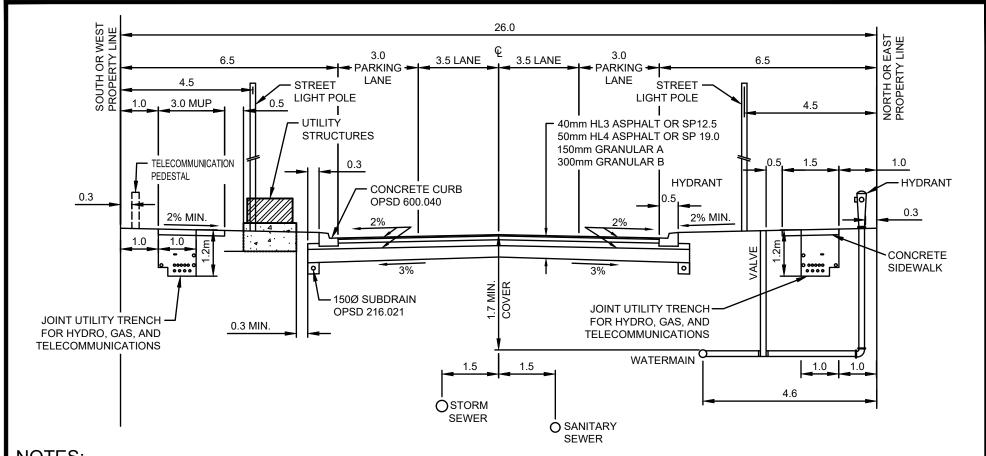


- 1. ALL DIMENSIONS ARE IN METRES UNLESS OTHERWISE SPECIFIED.
- 2. MINIMUM PAVEMENT AND ROAD STRUCTURE DESIGN AS PER TOWNSHIP OF SEVERN ENGINEERING CRITERIA OR AS PER GEOTECHNICAL INVESTIGATION RECOMMENDATION.
- 3. ALL SERVICE LOCATIONS SHOWN ARE FOR GUIDELINE PURPOSES ONLY AND MAY DEVIATE AS PER THE DIRECTION OF THE TOWNSHIP WHEN STANDARD LOCATION CANNOT BE ACHIEVED.
- 4. ALL WATER CURB STOPS TO BE PLACED ON STREETLINE.
- 5. BOULEVARD TO BE RESTORED WITH 150mm TOPSOIL & SOD.
- 6. SEE JOINT UTILITY TRENCH STANDARD DRAWING FOR 4 PARTY DETAILS.

П		NO.	REVISION	APR'D	DATE		APR'D:	DATE:	2023
ı		1	2023 UPDATE		DEC/23	TOWNSHIP OF SEVERN	DRAWN:	SCALE:	NTS
•	— Township of —					LIDDAN DECIDENTIAL DOAD			
ı	A 1000000000000000000000000000000000000					URBAN RESIDENTIAL ROAD 26.0m ROAD ALLOWANCE	STD. No.	204	
	SEVERN					13.0m ASPHALT	015.110.		

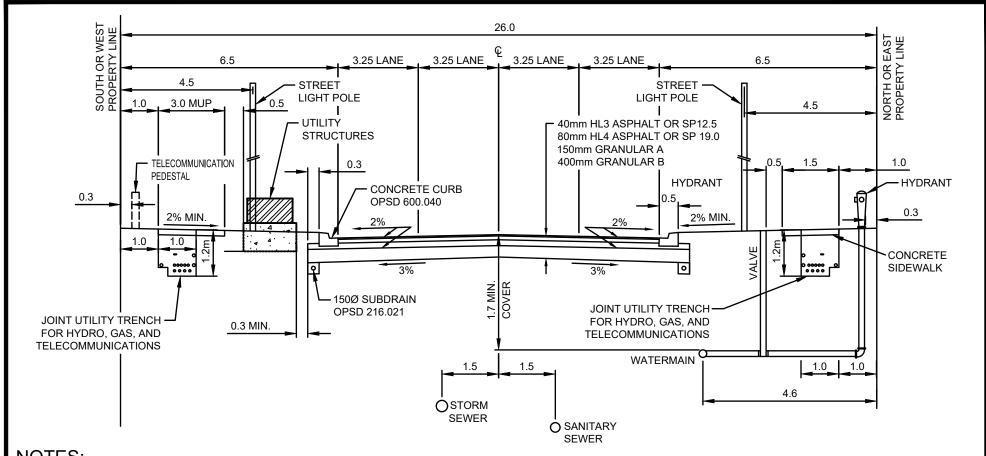


- ALL DIMENSIONS ARE IN METRES UNLESS OTHERWISE SPECIFIED.
- 2. MINIMUM PAVEMENT AND ROAD STRUCTURE DESIGN AS PER TOWNSHIP OF SEVERN ENGINEERING CRITERIA OR AS PER GEOTECHNICAL INVESTIGATION RECOMMENDATION.
- 3. ALL SERVICE LOCATIONS SHOWN ARE FOR GUIDELINE PURPOSES ONLY AND MAY DEVIATE AS PER THE DIRECTION OF THE TOWNSHIP WHEN STANDARD LOCATION CANNOT BE ACHIEVED.
- 4. ALL WATER CURB STOPS TO BE PLACED ON STREETLINE.
- 5. BOULEVARD TO BE RESTORED WITH 150mm TOPSOIL & SOD.
- 6. SEE JOINT UTILITY TRENCH STANDARD DRAWING FOR 4 PARTY DETAILS.

		NO.	REVISION	APR'D	DATE		APR'D:	DATE:	2023
		1	2023 UPDATE		DEC/23	TOWNSHIP OF SEVERN	DRAWN:	SCALE:	NTS
ı	— Township of —					URBAN COLLECTOR ROAD			
ı	A CONTRACTOR OF CONTRACTOR					26.0m ROAD ALLOWANCE	STD. No.	205	
ı	SEVERN					13.0m ASPHALT	01D. NO.	200	

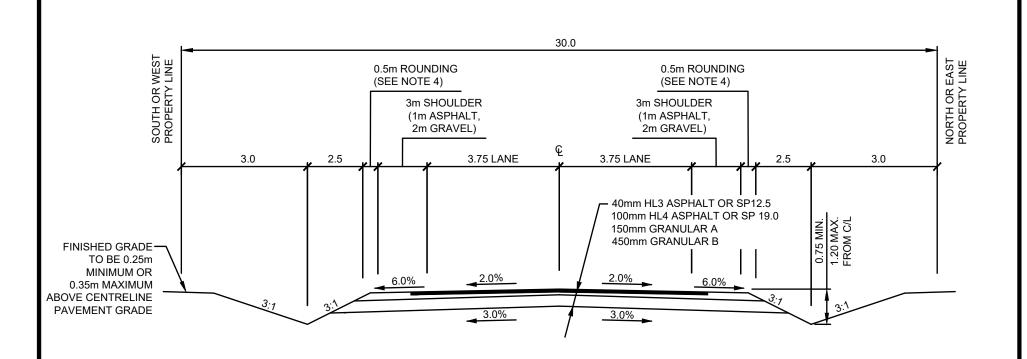


- ALL DIMENSIONS ARE IN METRES UNLESS OTHERWISE SPECIFIED.
- 2. MINIMUM PAVEMENT AND ROAD STRUCTURE DESIGN AS PER TOWNSHIP OF SEVERN ENGINEERING CRITERIA OR AS PER GEOTECHNICAL INVESTIGATION RECOMMENDATION.
- 3. DITCH GRADE TO BE MIN. 0.5%, MAX. 6.0% AND RESTORED WITH 150mm TOPSOIL & SEED (MIX TO BE APPROVED BY TOWNSHIP).
- 4. WHERE GUIDE RAIL IS REQUIRED THE ROUNDING IS TO BE INCREASED TO 1m.

	NO.	REVISION	APR'D	DATE		APR'D:	DATE:	2023
	1	2023 UPDATE		DEC/23	TOWNSHIP OF SEVERN	DRAWN:	SCALE:	NTS
— Township of —					RURAL ARTERIAL ROAD (OPEN DITCH)			
X 10 00000000 Mg/1 (0.00)					30.0m ROAD ALLOWANCE	STD. No.	206	
SEVERN					2-LANE WITHOUT ACTIVE TRANSPORTATION INCLUDED	C1D. NO.	200	

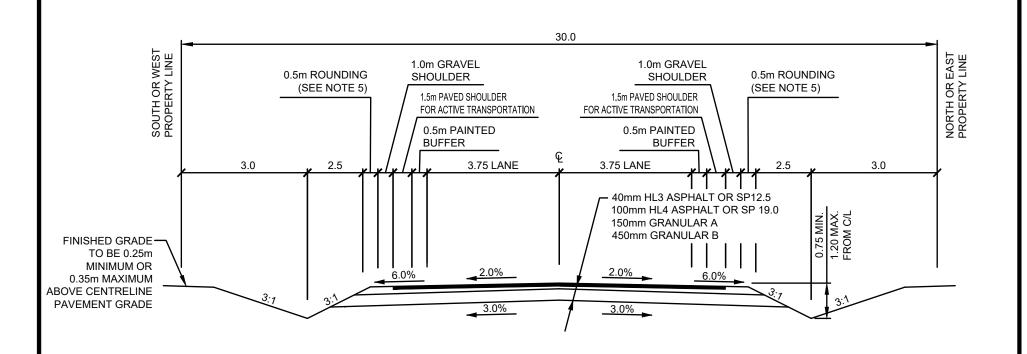

- ALL DIMENSIONS ARE IN METRES UNLESS OTHERWISE SPECIFIED.
- MINIMUM PAVEMENT AND ROAD STRUCTURE DESIGN AS PER TOWNSHIP OF SEVERN ENGINEERING CRITERIA OR AS PER GEOTECHNICAL INVESTIGATION RECOMMENDATION.
- 3. DITCH GRADE TO BE MIN. 0.5%, MAX. 6.0% AND RESTORED WITH 150mm TOPSOIL & SEED (MIX TO BE APPROVED BY TOWNSHIP).
- 4. SUITABILITY FOR ACTIVE TRANSPORTATION FACILITIES TO BE REVIEWED AS PER OTM BOOK 18 AND CONFIRMED WITH TOWNSHIP.
- 5. WHERE GUIDE RAIL IS REQUIRED THE ROUNDING IS TO BE INCREASED TO 1m.

	NO.	REVISION	APR'D	DATE		APR'D:	DATE:	2023
	1	2023 UPDATE		DEC/23	TOWNSHIP OF SEVERN	DRAWN:	SCALE:	NTS
— Township of —					RURAL ARTERIAL ROAD (OPEN DITCH)			
A SECOND OF THE PERSON					30.0m ROAD ALLOWANCE	STD. No.	207	
SEVERN					2-LANE WITH ACTIVE TRANSPORTATION INCLUDED	015.140.	201	

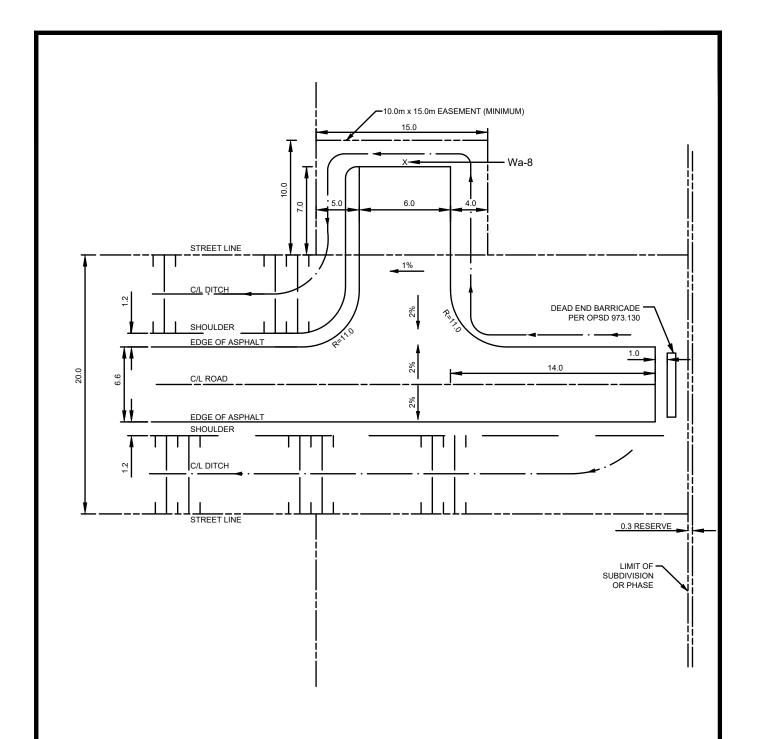


- ALL DIMENSIONS ARE IN METRES UNLESS OTHERWISE SPECIFIED.
- NO PARKING SIGNS TO BE INSTALLED IN AREA OF TEMPORARY TURNAROUND.

NO.	REVISION	APR'D	DATE
1	2023 UPDATE & RENUMBERED		DEC/23

	TOWNSHIP OF SEVERN	APR'D:	DATE:	
	TOWNSHIP OF SEVERN	DRAWN:	SCALE:	
SEVERN	TEMPORARY TURNAROUND RESIDENTIAL (RURAL)	STD. No.	208	


2012 NTS

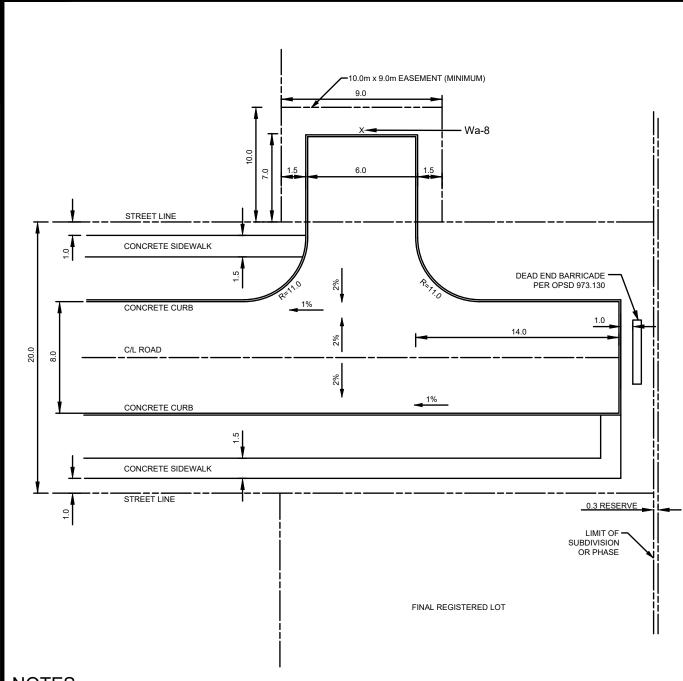

- ALL DIMENSIONS ARE IN METRES UNLESS OTHERWISE SPECIFIED.
- 2. GUTTER TO BE DETAILED ON ENGINEERING DRAWINGS. MINIMUM GRADE TO BE 1%.
- 3. THE LOCATION OF SIDEWALK TO BE DETAILED ON THE ENGINEERING DRAWINGS.
- 4. ALL CURB RADII ARE TO FACE OF CURBS.
- NO PARKING SIGNS TO BE INSTALLED IN AREA OF TEMPORARY TURNAROUND.

NO.	REVISION	APR'D	DATE
1	2023 UPDATE & RENUMBERED		DEC/23

	TOWNSHIP OF SEVERN	APR'D:	DATE:	2012
	TOWNSHIP OF SEVERN	DRAWN:	SCALE:	NTS
Township of — SEVERN	TEMPORARY TURNAROUND RESIDENTIAL (URBAN)	STD. No.	209	

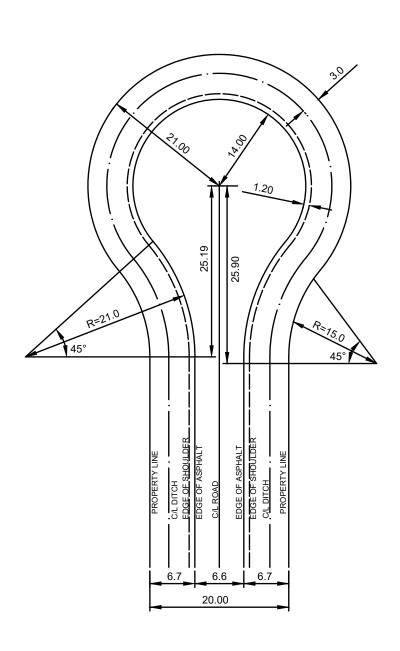


- 1. ALL DIMENSIONS ARE IN METRES UNLESS OTHERWISE SPECIFIED.
- DETAIL OF GRADING OF BULB AREAS OF CUL-DE-SAC TO BE SHOWN ON PROFILE DRAWINGS.
- CUL-DE-SAC DRAINAGE TO BE DIRECTED TOWARDS THE BEGINNING OF THE BULB. MINIMUM DITCH GRADE TO BE 2%.
- 4. DEAD END/NO EXIT SIGNAGE TO BE PROVIDED AT ENTRANCE TO CUL-DE-SAC.
- 5. CENTRAL ISLANDS ARE NOT PERMITTED.
- 6. NO PARKING SIGNS TO BE INSTALLED ALONG THE CUL-DE-SAC.

NO.	REVISION	APR'D	DATE
1	2023 UPDATE & RENUMBERED		DEC/23

Township of —

TOWNSHIP OF SEVERN	APR'D: DATE:		2012
TOWNSHIP OF SEVERN	DRAWN: SCALE:		NTS
RESIDENTIAL CUL-DE-SAC (RURAL) 20.0m ROAD ALLOWANCE 6.6m ASPHALT	STD. No.	STD. No. 210	

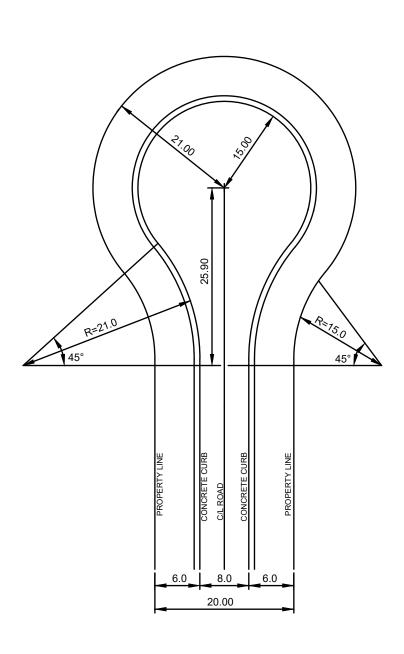


- ALL DIMENSIONS ARE IN METRES UNLESS OTHERWISE SPECIFIED.
- DETAIL OF GRADING OF BULB AREAS OF CUL-DE-SAC TO BE SHOWN ON PROFILE DRAWINGS.
- CUL-DE-SAC DRAINAGE TO BE DIRECTED TOWARDS THE BEGINNING OF THE BULB.
- 4. DEAD END/NO EXIT SIGNAGE TO BE PROVIDED AT ENTRANCE TO CUL-DE-SAC.
- 5. CENTRAL ISLANDS ARE NOT PERMITTED.
- NO PARKING SIGNS TO BE INSTALLED ALONG THE CUL-DE-SAC.

1	2023 UPDATE	DEC/23

Township of SFVFR	N


TOWNSHIP OF SEVERN	APR'D:	DATE:	: 2023	
TOWNSHIP OF SEVERN	DRAWN: SCALE:		NTS	
RESIDENTIAL CUL-DE-SAC (URBAN) 20.0m ROAD ALLOWANCE 8.0m ASPHALT	'			

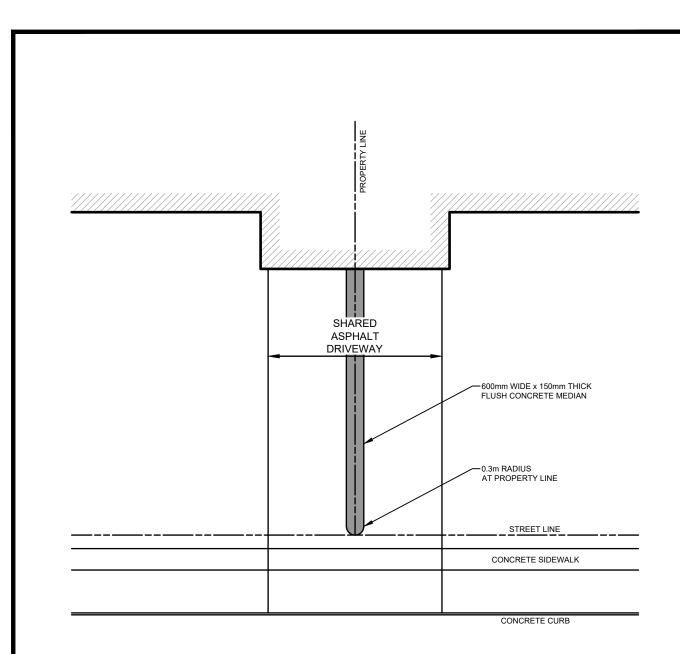

NO.	REVISION	APR'D	DATE
1	2023 UPDATE		DEC/23

SEVERN	


TOWNSHIP OF SEVERN	APR'D:	DATE:	2023
TOWNSHIP OF SEVERN	DRAWN:	SCALE:	NTS
SHARED DRIVEWAY DELINEATION	STD. No.	212	

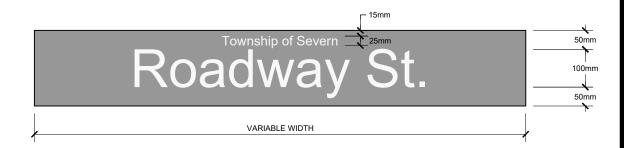


- 1. ALL DIMENSIONS ARE IN MILLIMETRES UNLESS OTHERWISE SPECIFIED.
- 2. "TOWNSHIP OF SEVERN" IS TO BE INCLUDED AT THE TOP OF THE SIGN.
- 3. BACKGROUND TO BE GREEN, TYPE I RETROREFLECTIVITY.
- 4. TEXT TO BE WHITE, TYPE I RETROREFLECTIVITY USING FHWA (HIGHWAY GOTHIC) FONT.
- 5. SIGNS ARE TO BE EXTRUDED ALUMINUM WITH 2.3mm THICKNESS.
- 6. STREET NAME TO APPEAR ON BOTH SIDES OF THE SIGN.
- 7. SIGN TO BE LOCATED IN ACCORDANCE WITH OTM AND AS APPROVED BY THE TOWNSHIP.

NO.	REVISION	APR'D	DATE
1	2023 UPDATE		DEC/23

	TOWNSHIP OF SEVERN	APR'D:	DATE:	2023
	TOWNSHIP OF SEVERIN	DRAWN:	SCALE:	NTS
Township of —	STREET NAME SIGN (G216)	STD. No.	213	

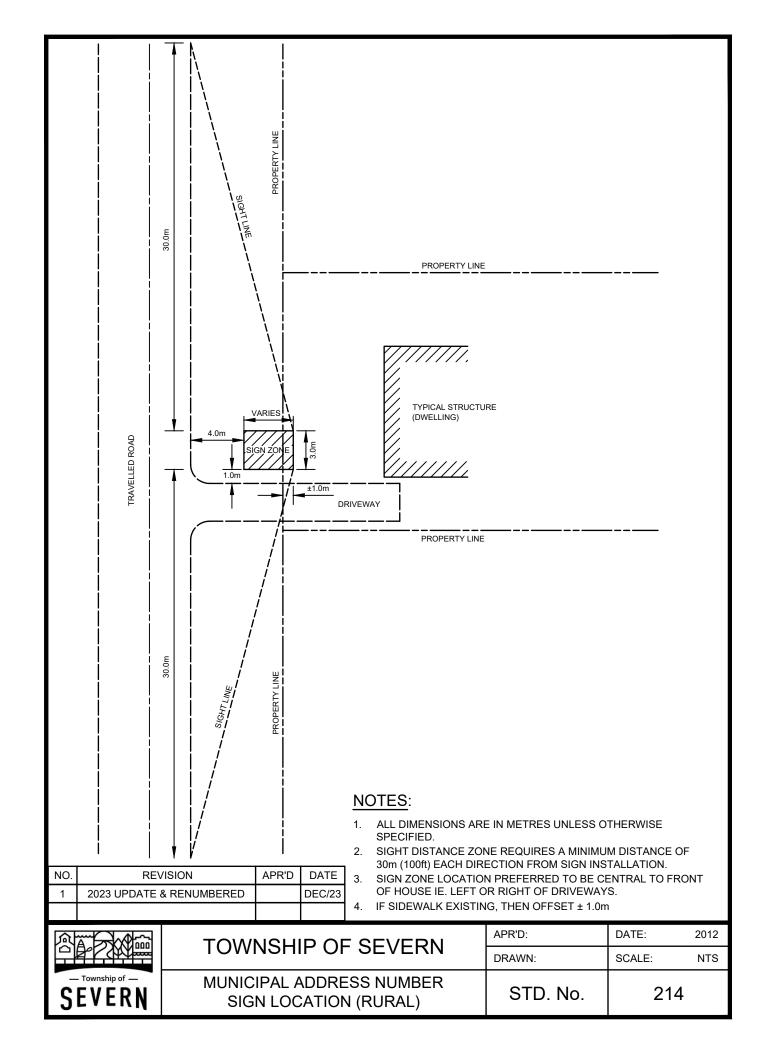


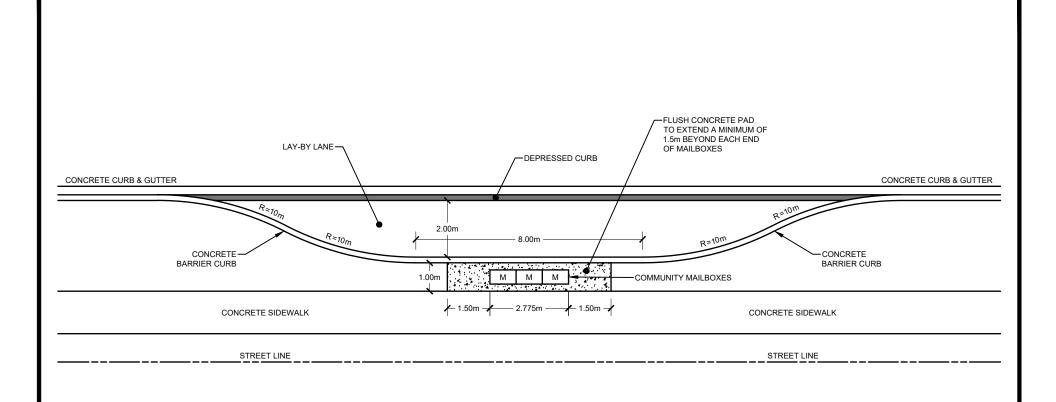

	1
— Township of —	
OFVEDN	
SEVERN	

NO.	REVISION	APR'D	DATE	
1	2023 UPDATE		DEC/23	

TOWNSHIP OF SEVERN	APR'D:	DATE:	2023
TOWNSHIP OF SEVERN	DRAWN:	SCALE:	NTS
URBAN COMMUNITY MAILBOX LAY-BY	STD. No.	215	

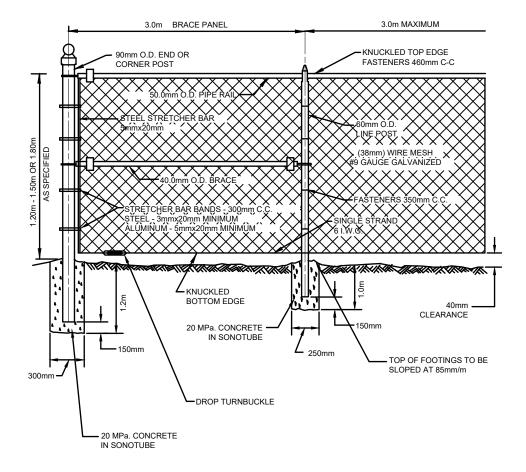

- 1. ALL DIMENSIONS ARE IN MILLIMETRES OR METRES UNLESS OTHERWISE SPECIFIED.
- 2. LENGTH OF POSTS


FENCE POST LOCATION	1.20 m FENCE	1.50 m FENCE	1.80 m FENCE
END, CORNER OR RESTRAINING	2.30 m	2.60 m	2.90 m
LINE POST	2.05 m	2.36 m	2.65 m

- 3. FASTENERS 6 I.W.G. GALVANIZED STEEL OR ALUMINUM WIRE.
- 4. ALL POSTS, PIPE RAILS AND FASTENERS TO BE GALVANIZED.
- 5. BRACE RAILS TO BE ELIMINATED ON 1.20 m HIGH FENCE.
- FENCE FABRIC SHALL BE TYPE 1 STEEL FABRIC 3.0 mm DIA. STEEL WIRE, STYLE 3 LIGHT STEEL WIRE, GALVANIZED BEFORE WEAVING.
- 7. FENCING REQUIREMENTS FOR PUBLIC WALKWAYS ARE TO BE RANGE FROM 1.2 m TO 1.8 m. A FENCE HEIGHT OF 1.2 m IS TO BE SPECIFIED BETWEEN STREET LINE AND THE FRONT OF THE DWELLING. FENCING HEIGHTS BEYOND THE FRONT OF THE DWELLING ARE TO 1.8 m.

2012 NTS

NO.	REVISION	APR'D	DATE
1	2023 UPDATE		DEC/23


	TOWNSHIP OF SEVERN	APR'D:	DATE:
	TOWNSHIP OF SEVERN	DRAWN:	SCALE:
SEVERN	CHAIN LINK SECURITY FENCE	STD. No.	301

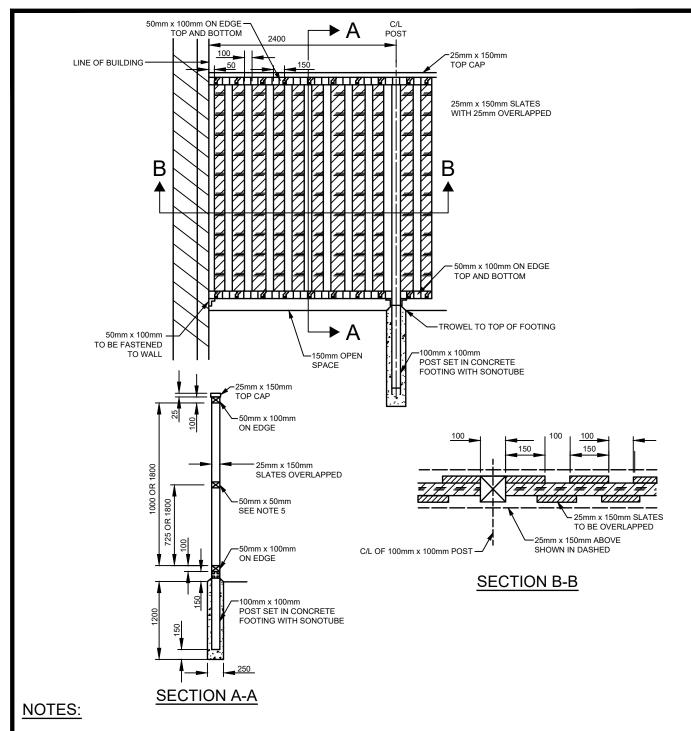

- 1. ALL DIMENSIONS ARE IN MILLIMETRES UNLESS OTHERWISE SPECIFIED.
- 2. USE CONSTRUCTION GRADE CEDAR OR PRESSURE TREATED. DO NOT USE SPRUCE OR HEMLOCK.
- 3. USE APPROVED WOOD STAIN.
- 4. USE STEEL ZINC COATED TWISTED NAILS No. 11 GAUGE 64 mm x 76 mm.
- 5. FOR FENCE 1.8 m OR HIGHER 50 mm x 50 mm MUST BE USED AS SHOWN IN SECTION A-A.
- USE GALVANIZED FENCE BRACKETS.
- FOR WALKWAYS, THE FENCE HEIGHT SHOULD BE 1.2m HIGH BETWEEN STREETLINE AND FRONT WALL OF DWELLINGS ON ADJACENT LOTS AND 1.8 m FOR THE REMAINDER.

NO.	REVISION	APR'D	DATE
1	2023 UPDATE		DEC/23


	TOWNSHIP OF SEVERN	APR'D:	DATE:	2012
	TOWNSHIP OF SEVERN	DRAWN:	SCALE:	NTS
SEVERN	WOOD PRIVACY FENCE	STD. No.	302	

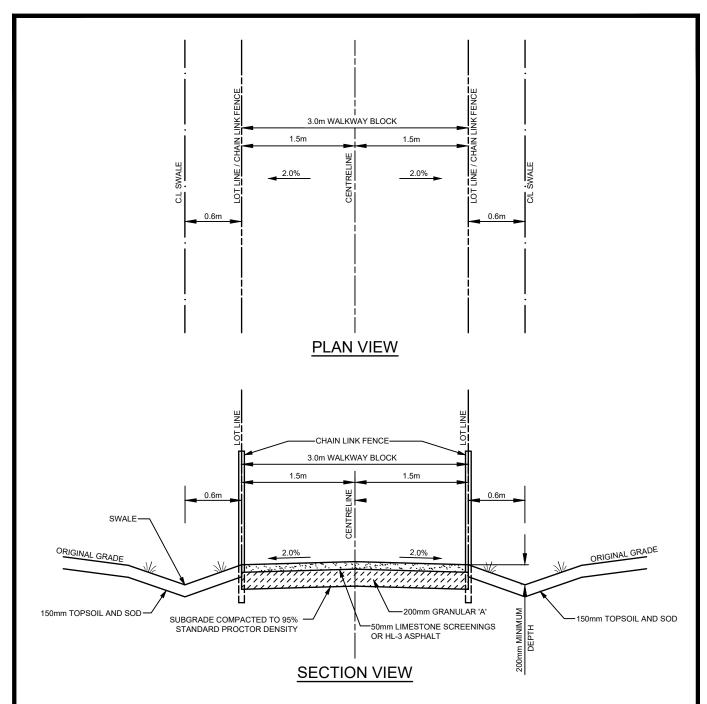

- 1. ALL DIMENSIONS ARE IN METRES UNLESS OTHERWISE SPECIFIED.
- 2. ALL GRANULAR MATERIALS TO BE COMPACTED TO 100% STANDARD PROCTOR DENSITY. REQUIRED SURFACE TREATMENT TO BE CONFIRMED WITH THE TOWNSHIP.
- PROPOSED LONGITUDINAL GRADE OF WALKWAY TO BE IDENTIFIED ON ENGINEERING DRAWINGS. MINIMUM LONGITUDINAL GRADE TO BE 1.5%.
- 4. PROVIDE POSITIVE OUTLET FOR SWALE (i.e. DITCH / STORM SEWER).
- 5. PROVIDE BOLLARD AT ENTRANCE / EXIT ON PROPERTY LINE.
- 6. LIGHTING TO BE PROVIDED AT ENTRANCE/EXIT AS REQUIRED BY THE TOWNSHIP.

NO.	REVISION	APR'D	DATE
1	2023 UPDATE		DEC/23


	TOWNSHIP OF SEVERN	APR'D:	DATE:	2012
	TOWNSHIP OF SEVERN	DRAWN:	SCALE:	NTS
SEVERN	PEDESTRIAN WALKWAY	STD. No.	303	

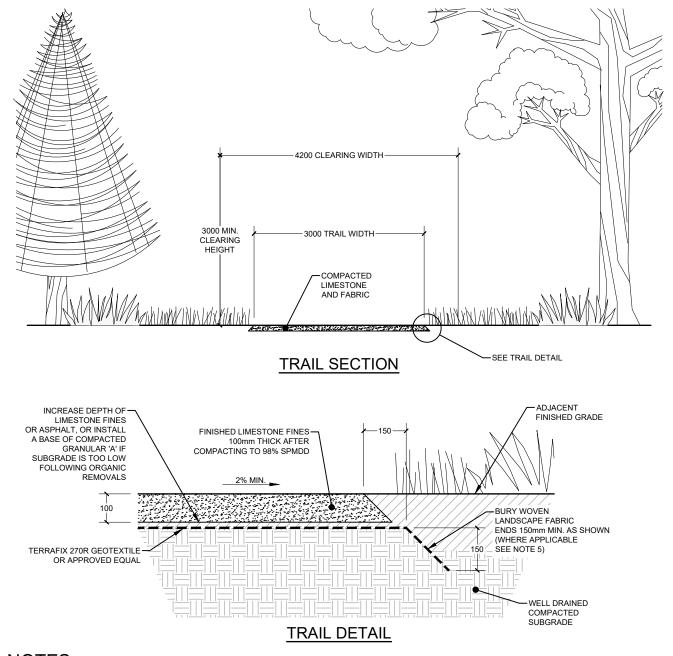


- 1. ALL DIMENSIONS ARE IN MILLIMETRES UNLESS OTHERWISE SPECIFIED.
- 2. EXCAVATE ALL TOPSOIL AND ORGANIC MATTER UNDER TRAIL BED.
- 3. STANDARD DETAIL REFLECTS IDEAL SUBGRADE CONDITIONS ON COMPACTED, WELL DRAINED SOIL. ADDITIONAL GRANULAR MATERIAL MAY BE REQUIRED TO SUIT CONDITIONS.
- 4. THE 270R GEOTEXTILE IS TO BE USED UNDER IDEAL AND DRY SOIL CONDITIONS. GEOTEXTILE REQUIREMENTS MAY BE UPGRADED TO SUIT SOIL CONDITIONS AND MAY REQUIRE THE USE OF GEO-GRIDS OR WOVEN FABRICS.
- 5. GEOTEXTILE TO BE FOLDED AND BURIED INTO SUBGRADE 150mm AS SHOWN FOR NEW DEVELOPMENT. WHERE TRAIL IS CONSTRUCTED THROUGH UNDISTURBED LANDSCAPE, THE GEOTEXTILE CAN REMAIN FLUSH WITH THE SUBGRADE SURFACE IF BURYING WOULD CAUSE UNNECESSARY DISTURBANCE TO EXISTING VEGETATION.
- 6. DIRECTION OF CROSS SLOPE TO BE ADJUSTED TO SUIT GRADING REQUIREMENTS.

NO.	REVISION	APR'D	DATE
1	2023 UPDATE		DEC/23

ı		TOWNSHIP OF SEVERN	APR'D:	DATE:	2023
ı		TOWNSHIP OF SEVERIN	DRAWN:	SCALE:	NTS
SEVERN	MULTI-USE RECREATION TRAIL THROUGH NATURALIZED AREA	STD. No.	304		

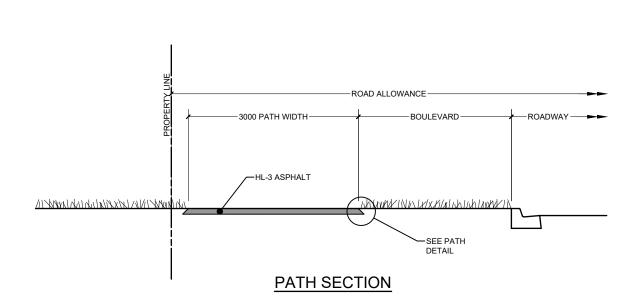


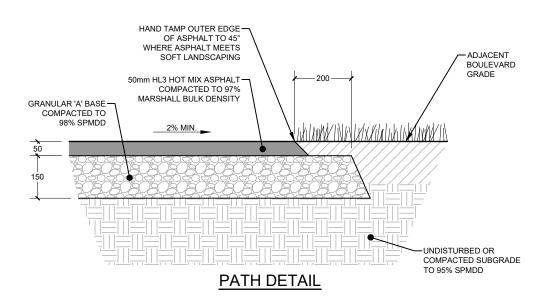

- 1. ALL DIMENSIONS ARE IN MILLIMETRES UNLESS OTHERWISE SPECIFIED.
- 2. EXCAVATE ALL TOPSOIL AND ORGANIC MATTER UNDER TRAIL BED.
- 3. STANDARD DETAIL REFLECTS IDEAL SUBGRADE CONDITIONS ON COMPACTED, WELL DRAINED SOIL. ADDITIONAL GRANULAR MATERIAL MAY BE REQUIRED TO SUIT CONDITIONS.
- 4. DIRECTION OF CROSS SLOPE TO BE ADJUSTED TO SUIT GRADING REQUIREMENTS.
- 5. ALL GRANULAR WORK TO BE IN ACCORDANCE WITH OPSS 314.
- 6. ALL HOT MIX ASPHALT WORK TO BE IN ACCORDANCE WITH OPSS 311.
- 7. ROLL ASPHALT CONTINUOUSLY TO DENSITY NOT LESS THAN 97% MARSHALL BULK DENSITY.
- 8. DO NOT BACKFILL AGAINST ASPHALT FOR MIN. 48 HOURS.

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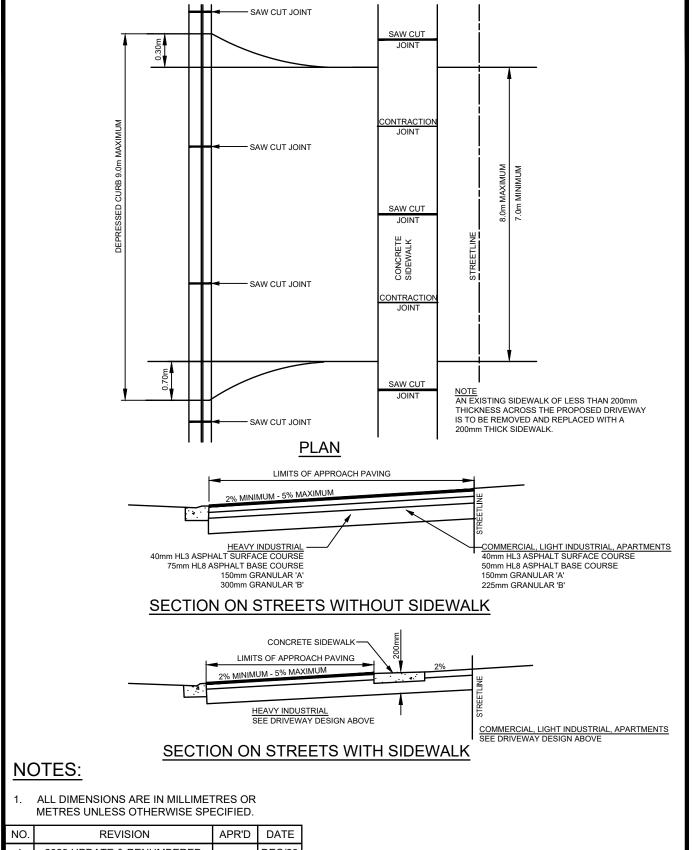
	TOWNSHIP OF SEVERN	APR'D:	DATE:	2023
	TOWNSHIP OF SEVERN	DRAWN:	SCALE:	NTS
Township of —	MULTI-USE PATH WITHIN ROAD ALLOWANCE	STD. No.	305	

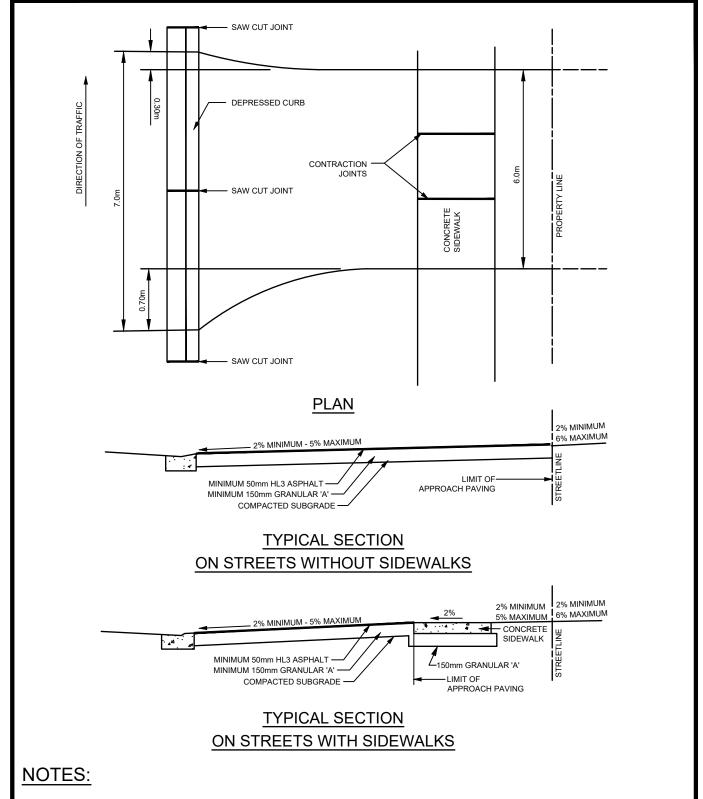

 ALL DIMENSIONS ARE IN MILLIMETRES OR METRES UNLESS OTHERWISE SPECIFIED.

NO.	REVISION	APR'D	DATE
1	2023 UPDATE & RENUMBERED		DEC/23


	TOWNSHIP OF SEVERN	APR'D:	DATE: 2	2012
	TOWNSHIP OF SEVERIN	DRAWN:	SCALE:	NTS
— Township of — SEVERN	DRIVEWAY APPROACH PAVING FOR RESIDENTIAL DRIVEWAYS	STD. No.	306	



NO.	REVISION	APR'D	DATE
1	2023 UPDATE & RENUMBERED		DEC/23

— Township of —
SEVERN


TOWNSHIP OF SEVERN	APR'D:	DATE:	2012
TOWNSHIP OF SEVERN	DRAWN:	SCALE:	NTS
DRIVEWAY APPROACH PAVING COMMERCIAL, INDUSTRIAL AND APARTMENTS	STD. No.	307	

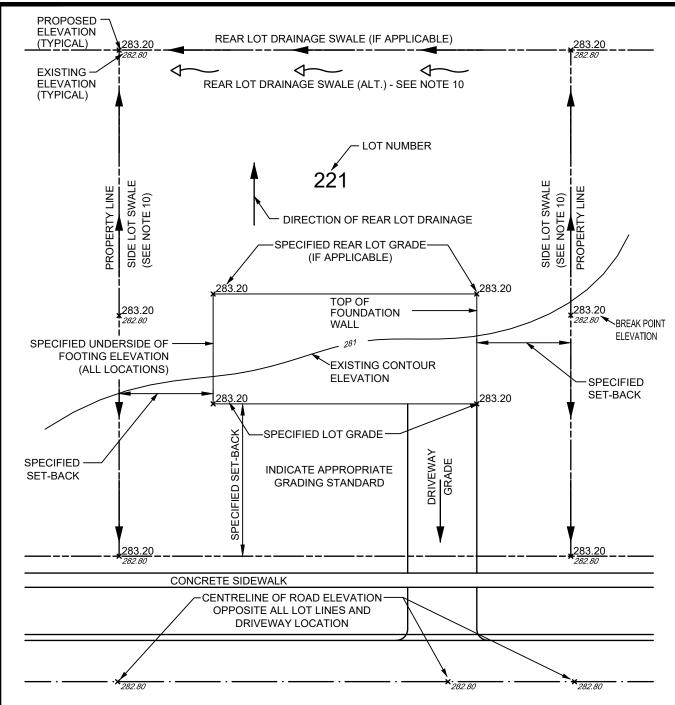

- ALL CATCHBASIN LOCATIONS MUST BE SHOWN ON GRADING PLAN.
- ALL EASEMENTS MUST BE SHOWN ON GRADING PLAN.
- PROVIDE MAIN FLOOR AND BASEMENT ELEVATIONS.
- SPECIFY PROPOSED GRADES ON SWALES.
- IDENTIFY PROPOSED LOCATION AND DIMENSION OF SEPTIC TILE BED AND RESERVE BED AREA (WHERE REQUIRED).
- PROVIDE REGISTERED PLAN NUMBER.
- MAXIMUM DRIVEWAY GRADE TO BE 5% 7.
- REVISION APR'D DATE **2023 UPDATE** DEC/23
- SHOW SERVICE LATERAL INVERT ELEVATION AT STREET LINE AND CURB STOP LOCATION (WHEN APPLICABLE)
- SHOW ALL ABOVEGROUND FEATURES AND UTILITY INSTALLATIONS IN BOULEVARD.
- DRAINAGE SWALES TO BE ON PROPERTY LINE. SET SWALE ENTIRELY WITHIN LOT IF ABUTTING PROPERTY NOT UNDERGOING DEVELOPMENT.

	TOWNSHIP OF SEVERN
— Township of —	TYPICAL LEGEND FOR
SEVERN	LOT GRADING PLAN


STD. No.	401	
DRAWN:	SCALE:	NTS
APR'D:	DATE:	2012

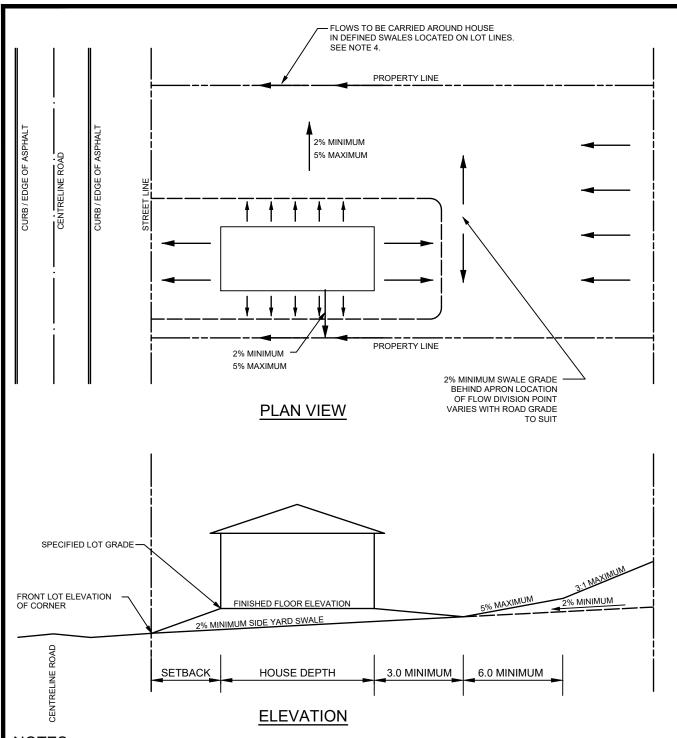

- 1. ALL DIMENSIONS ARE IN METRES UNLESS OTHERWISE SPECIFIED.
- 2. SPECIFIED LOT GRADE SHALL BE MINIMUM 0.30m ABOVE HIGHEST FRONT LOT CORNER.
- 3. DRIVEWAYS ARE NOT TO BE USED AS AN OUTLET FOR ANY SIDEYARD SWALE.
- 4. DRAINAGE SWALES TO BE ON PROPERTY LINE. SET SWALE ENTIRELY WITHIN LOT IF ABUTTING PROPERTY NOT UNDERGOING DEVELOPMENT.

NO.	REVISION	APR'D	DATE
1	2023 UPDATE		DEC/23

	TOWNSHIP OF SEVERN	APR'D:	DATE:	2012
	TOWNSHIP OF SEVERN	DRAWN: SCALE:		NTS
SEVERN	FRONT LOT DRAINAGE	STD. No.	402	

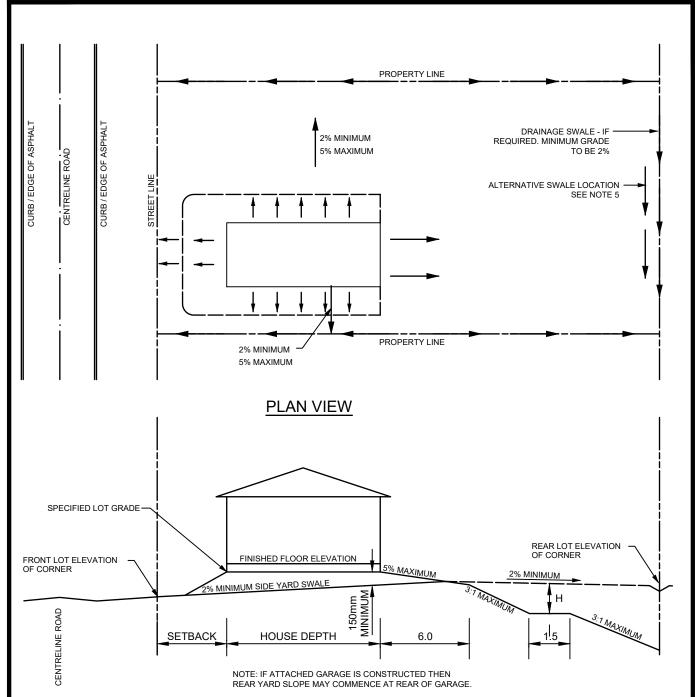



### **ELEVATION**

- 1. ALL DIMENSIONS ARE IN METRES UNLESS OTHERWISE SPECIFIED.
- 2. SPECIFIED LOT GRADE SHALL BE MINIMUM 0.30m ABOVE HIGHEST FRONT LOT CORNER.
- 3. DRIVEWAYS ARE NOT TO BE USED AS AN OUTLET FOR ANY SIDEYARD SWALE.
- 4. 'H' DIMENSION TO BE 1.8m MAXIMUM, UNLESS UNDISTURBED EXISTING SLOPE. TERRACE CAN BE ELIMINATED ON SLOPES OF 4:1 OR LESS.
- DRAINAGE SWALES TO BE ON PROPERTY LINE. SET SWALE ENTIRELY WITHIN LOT IF ABUTTING PROPERTY NOT UNDERGOING DEVELOPMENT.

NO.	REVISION	APR'D	DATE
1	2023 UPDATE		DEC/23

	TOWNSHIP OF SEVERN	APR'D: DATE:		2012
	TOWNSHIP OF SEVERN	DRAWN:	SCALE:	NTS
Township of — SEVERN	REAR LOT DRAINAGE	STD. No.	403	

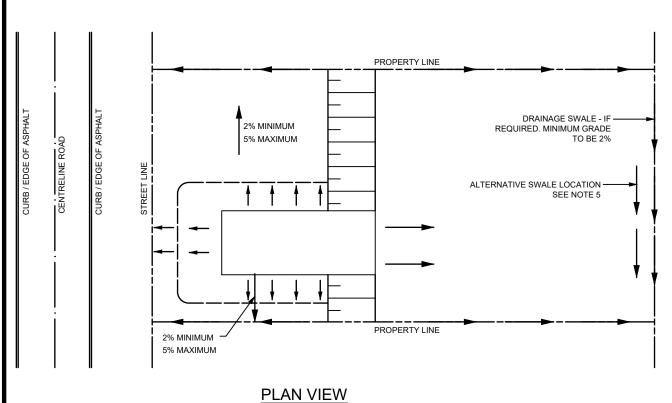

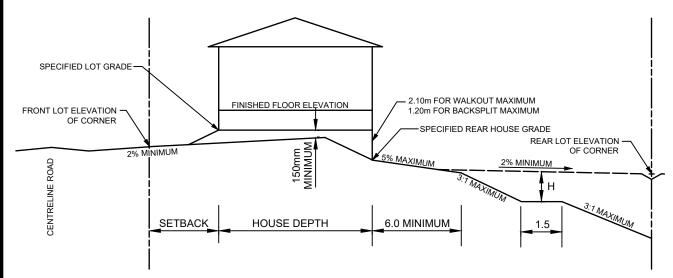


## **ELEVATION**

- ALL DIMENSIONS ARE IN METRES UNLESS OTHERWISE SPECIFIED.
- SPECIFIED LOT GRADE SHALL BE MINIMUM 0.30m ABOVE HIGHEST FRONT LOT CORNER.
- 'H' DIMENSION TO BE 1.8m MAXIMUM, UNLESS UNDISTURBED EXISTING SLOPE. TERRACE CAN BE ELIMINATED ON SLOPES OF 4:1 OR LESS.
- REAR HOUSE GRADE MUST ALSO BE SPECIFIED ON LOT GRADING PLANS WHEN THIS HOUSE TYPE IS PROPOSED.
- DRAINAGE SWALES TO BE ON PROPERTY LINE. SET SWALE ENTIRELY WITHIN LOT IF ABUTTING PROPERTY NOT UNDERGOING DEVELOPMENT.

NO.	REVISION	APR'D	DATE
1	2023 UPDATE		DEC/23

— Township of —
SEVERN

TOWNSHIP OF SEVERN	APR'D:	DATE:	2012
TOWNSHIP OF SEVERN	DRAWN:	SCALE:	NTS
REAR LOT DRAINAGE FOR WALKOUT OR BACK SPLIT HOUSE	STD. No.	404	

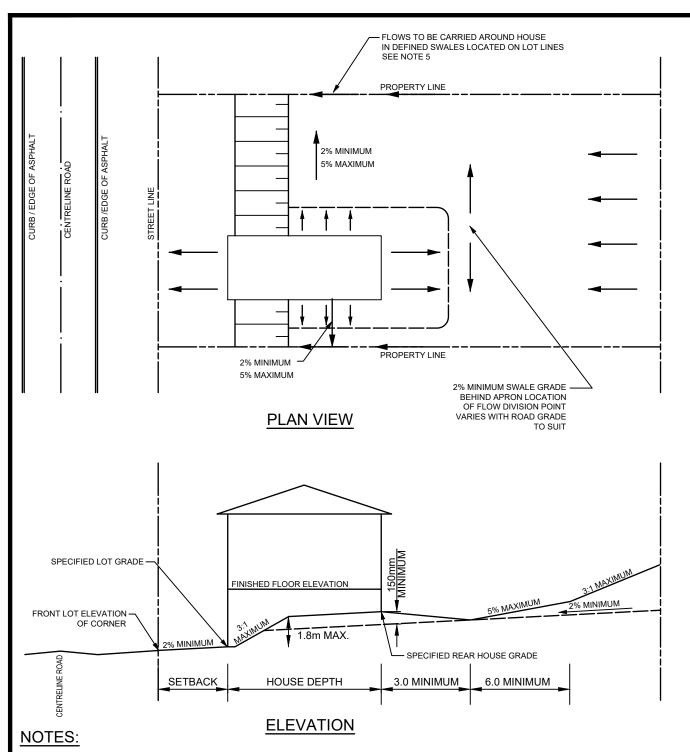

- 1. ALL DIMENSIONS ARE IN METRES UNLESS OTHERWISE SPECIFIED.
- 2. SPECIFIED LOT GRADE SHALL BE MINIMUM 0.30m ABOVE HIGHEST FRONT LOT CORNER.
- 3. DRIVEWAYS ARE NOT TO BE USED AS AN OUTLET FOR ANY SIDEYARD SWALE.
- 4. REAR HOUSE GRADE MUST BE SPECIFIED ON LOT GRADING PLANS WHEN THIS HOUSE TYPE IS PROPOSED.
- DRAINAGE SWALES TO BE ON PROPERTY LINE. SET SWALE ENTIRELY WITHIN LOT IF ABUTTING PROPERTY NOT UNDERGOING DEVELOPMENT.

NO.	REVISION	APR'D	DATE
1	2023 UPDATE		DEC/23

Township of — SEVERN	TOWNSHIP OF SEVERN	APR'D: DATE:	DATE:	2012
	TOWNSHIP OF SEVERIN	DRAWN:	SCALE:	NTS
	FRONT LOT DRAINAGE FOR FRONT SPLIT HOUSE	STD. No.	405	

			KEY PLAN	
			NOR ARRO	TH ow
	1. PPE SIZES ARE IS NOT ARE THE SIZE AND ROCKING. 1. ALL CONTROLLED AND ARE SIZES AND AREA OF THE SIZES AND AR	NAME OF DEVELOPMENT CORPOR  MAKE OF DEVELOPMENT CORPOR  MAKE OF DEVELOPMENT CORPOR  MAKE OF DEVELOPMENT CORPOR  TOWNSHIP OF SEVERN  DRAWING TITLE  DRAWING TITLE  TOWNSHIP FILE #	COMSULTANT INFO    COMSULTANT INFO	x
	NO. REVISION APR'D DATE 1 2023 UPDATE DEC/2		APR'D: DA DRAWN: SC/	TE: 2012 ALE: NTS
Township of — SEVERN		STANDARD PLAN SHEET FOR DEVELOPMENT PROJECTS	STD. No.	501A

		KEY PLAN	
		NORTH ARROW	
	DRAWING TITLE SEE  100 RESIDENCE OF NAME SEE  10	CONSULTANT INFO  LE 1	
	NO. REVISION APR'D DATE 1 2023 UPDATE DEC/23  TOWNSHIP OF SEVERN  APR'D DATE DEC/23		
SEVERN	STANDARD PLAN SHEET FOR CAPITAL PROJECTS	STD. No.	501B

#### **GENERAL - CONSTRUCTION**

- A. ALL DIMENSIONS IN METRES AND PIPE SIZES IN MILLIMETRES UNLESS OTHERWISE NOTED.
- B. ALL WORK TO BE CARRIED OUT IN ACCORDANCE WITH TOWNSHIP OF SEVERN STANDARDS. OPSD AND OPSS. WHERE CONFLICT OCCURS. TOWNSHIP STANDARD TO GOVERN.
- C. WHERE OPS IS REFERENCED, IT MEANS THE MUNI VERSION, IF AVAILABLE.
- D. ROAD OCCUPANCY PERMIT MUST BE OBTAINED FROM THE ROAD AUTHORITY.
- E. LOCATIONS OF EXISTING SERVICES, INCLUDING UTILITIES, ARE NOT GUARANTEED. CONTRACTOR IS REQUIRED TO OBTAIN LOCATES, VERIFY LOCATIONS, AND ABIDE BY UTILITY REQUIREMENTS.
- F. TRENCH BACKFILL (OPSD 802.XXX AS APPLICABLE) TO BE SELECT NATIVE MATERIAL OR IMPORTED SELECT SUBGRADE TO OPSS 1010. BACKFILL TO BE PLACED IN MAXIMUM 150mm THICK LIFTS AND COMPACTED TO 95% OF THE MATERIAL'S STANDARD PROCTOR MAXIMUM DRY DENSITY (SPMDD).
- G. PIPE BEDDING TO BE GRANULAR 'A'. PIPE COVER TO BE GRANULAR 'B' MAX. AGGREGATE SIZE 25mm FOR RIGID PIPE AND GRANULAR 'A' FOR FLEXIBLE PIPE. (MINIMUM BEDDING DEPTH 150mm, MINIMUM COVER 300mm, COMPACTED TO A MINIMUM 95% SPMDD).
- H. CLEAR STONE WRAPPED IN FILTER FABRIC CAN BE SUBSTITUTED FOR BEDDING MATERIAL IF APPROVED BY THE TOWNSHIP.
- I. ALL MAINTENANCE HOLES ARE 1200mm DIAMETER UNLESS OTHERWISE SPECIFIED.
- J. ALL TOPSOIL AND EARTH EXCAVATION TO BE STOCK PILED OR REMOVED TO AN APPROVED SITE AS DIRECTED BY THE TOWNSHIP.
- K. THE OWNER'S ENGINEER SHALL PROVIDE BENCH MARK ELEVATIONS AND HORIZONTAL ALIGNMENT REFERENCE FOR THE CONTRACTOR. THE CONTRACTOR SHALL BE RESPONSIBLE FOR THE DETAILED LAYOUT OF THE WORK.
- L. ALL PROPERTY BARS TO BE PRESERVED AND REPLACED BY O.L.S. AT CONTRACTOR'S EXPENSE IF REMOVED DURING CONSTRUCTION.
- M. ALL MAINTENANCE HOLE AND CATCH BASIN FRAMES AND COVERS TO BE SET TO BASE COURSE HL4 ASPHALT ELEVATION AND RAISED PRIOR TO PLACEMENT OF FINAL COURSE HL3 ASPHALT TO THE SATISFACTION OF THE TOWNSHIP.
- N. THE CONTRACTOR SHALL MAKE HIS OWN ARRANGEMENTS FOR THE SUPPLY OF TEMPORARY WATER AND POWER.
- O. DEWATERING TO BE CARRIED OUT IN ACCORDANCE WITH OPSS-517 TO MAINTAIN ALL TRENCHES IN A DRY CONDITION. CONTRACTOR RESPONSIBLE FOR ENSURING CONFORMANCE WITH ALL MECP REQUIREMENTS AND PERMITS.
- P. ALL ENGINE DRIVEN PUMPS TO BE ADEQUATELY SILENCED. SUITABLE FOR OPERATION IN A RESIDENTIAL DISTRICT.
- Q. DISTURBED AREAS TO BE REINSTATED TO PREVIOUS CONDITION OR BETTER.
- R. THE CONTRACTOR IS RESPONSIBLE FOR PRESERVATION OF ALL EXISTING FACILITIES AS WELL AS CONTACTING ALL UTILITY COMPANIES PRIOR TO COMMENCING WORK AND COORDINATING CONSTRUCTION ACCORDINGLY.
- S. ALL EROSION AND SEDIMENT CONTROLS TO BE INSTALLED PRIOR TO COMMENCEMENT OF WORK, TO BE MAINTAINED THROUGHOUT CONSTRUCTION, AND REMAIN IN PLACE UNTIL COMPLETION OF CONSTRUCTION AND DIRECTION IS PROVIDED BY THE TOWNSHIP TO REMOVE.

	NO.	REVISION	APR'D	DATE	TOWNSHIP OF CEVEDN	APR'D:	DATE:	2012
	1	2023 UPDATE		DEC/23	TOWNSHIP OF SEVERN	DRAWN:	SCALE:	NTS
Township of —					GENERAL - CONSTRUCTION NOTES	STD. No.	502	

## STORM SEWERS

- A. M.H.,CBMH AND DICBMH TO BE PER OPSD 701.XXX (AS APPROPRIATE) C/W SUMP UNLESS NOTED OTHERWISE.
- B. STEPS TO BE PER OPSD 405.010.
- C. M.H. FRAMES AND GRATES TO BE PER OPSD 401.01 CLOSED COVER.
- D. C.B.'S TO BE PER OPSD 705.010, 705.020
- E. DICB'S TO BE PER OPSD 705.030, 705.040, 706.010, 706.020, 706.030, 706.040
- F. C.B.'S AND CBMH FRAMES AND GRATES TO BE PER OPSD 400.100 AND REAR LOT 400.120...
- G. PIPE SUPPORT AT M.H.'S, CB'S AND CBMH'S TO BE PER OPSD 708.020.
- H. C.B. LEADS 300mm DIA SINGLE AND 375mm DIA DOUBLE TO BE PER OPSD 708.010, 708.030.
- I. BEDDING AND COVER TO BE PER OPSD 802.010. (FLEXIBLE PIPE) GRANULAR 'A' EMBEDMENT MATERIAL OR OTHER APPROVED HOMOGENEOUS GRANULAR MATERIAL OR OPSD 802.030, 802.031 AND 802.032 (RIGID PIPE) GRANULAR 'A' BEDDING AND GRANULAR 'B' (MAXIMUM AGGREGATE SIZE 25mm) COVER.
- J. TRENCH BACKFILL TO BE SELECT NATIVE MATERIAL AS APPROVED BY ENGINEER OR IMPORTED GRANULAR MATERIAL.
- K. BACKFILL AND EMBEDMENT MATERIAL TO BE COMPACTED TO A DRY DENSITY OF AT LEAST 95% OF THE MATERIAL'S SPMDD.
- L. WHERE RESIDENTIAL STORM SEWER CONNECTIONS ARE REQUIRED, THE STORM SEWER SHALL BE OVERSIZED.
- M. FROST DEPTH IS ASSUMED TO BE 1.5m. ALL MAINTENANCE HOLES AND CATCHBASINS TO HAVE FROST STRAPS PER OPSD 701.100.

	NO.	REVISION	APR'D	DATE	TOWNSHIP OF SEVERN	APR'D:	DATE:	2012
	1	2023 UPDATE		DEC/23	TOWNSHIP OF SEVERN	DRAWN:	SCALE:	NTS
— Township of —					NOTES - STORM SEWERS	STD. No.	503	
SEVERN					NOTES - STORWISEWERS	31D. NO.	303	

#### SANITARY SEWERS

- A. M.H.'S TO BE PER OPSD 701.XXX AS APPROPRIATE.
- B. BENCHING TO BE PER OPSD 701.021. NOTE: MINIMUM HOLE SIZE IN WALL IF PRE-CAST RISER SECTION SHALL CONFORM WITH MANUFACTURER'S SPECIFICATIONS.
- C. STEPS TO BE PER OPSD 405.010.
- D. FROST STRAPS SHALL BE INSTALLED ON ALL MAINTENANCE HOLE AS PER OPSD 701.100
- E. BEDDING AND COVER TO BE PER OPSD 802.010 (FLEXIBLE PIPE), GRANULAR 'A' EMBEDMENT MATERIAL OR OTHER APPROVED HOMOGENEOUS GRANULAR MATERIAL.
- F. TRENCH BACKFILL TO BE SELECT NATIVE MATERIAL AS APPROVED BY ENGINEER OR IMPORTED GRANULAR MATERIAL.
- G. FRAMES AND COVERS TO BE PER OPSD 401.01 TYPE 'A' (CLOSED COVER).
- H. SERVICE CONNECTIONS TO BE PER OPSD 1006.010 (125mm), GRANULAR 'A' EMBEDMENT, TERMINATE 1.5m INSIDE THE PROPERTY LINE WITH A CLEANOUT TO THE SURFACE AT THE PROPERTY LINE 3.0m LEFT OF WATER SERVICE (FACING LOT) C/W 38mm x 89mm MARKER POST PAINTED GREEN. MINIMUM GRADE TO BE 2.0%.
- I. RADIUS BENDS TO BE USED ON SANITARY SEWER CONNECTIONS WHERE THE ANGLE OF CONNECTION BETWEEN THE SERVICE AND SEWER EXCEEDS 90°.
- J. BACKFILL AND EMBEDMENT MATERIAL TO BE COMPACTED TO A DRY DENSITY OF AT LEAST 95% OF THE MATERIAL'S SPMDD.
- K. CLEAR STONE WRAPPED WITH FILTER FABRIC CAN BE SUBSTITUTED FOR EMBEDMENT MATERIAL IF APPROVED BY THE ENGINEER.
- L. MAINTENANCE HOLE FRAMES TO BE SET TO BASE COURSE ASPHALT ELEVATION AND RAISED PRIOR TO PLACING SURFACE COURSE ASPHALT TO THE SATISFACTION OF THE TOWNSHIP.
- M. PIPE SUPPORT AT MAINTENANCE HOLES AS PER OPSD 708.020.
- N. ALL MAINTENANCE HOLES, UNLESS EXPRESSLY IDENTIFIED ARE 1200mm DIAMETER.
- O. GENERAL INSTALLATION AND TESTING OF SEWERS AND APPURTENANCES TO BE IN ACCORDANCE WITH OPSS 407, 408, 409 (CCTV), 410, 421 AND ALL SPECIFICATIONS REFERENCED WITHIN THE CONTRACT DOCUMENTS.
- P. ALL CONNECTIONS TO BE MADE WITH APPROVED PRE-MANUFACTURED TEES.

	NO.	REVISION	APR'D	DATE	TOWNSHIP OF SEVERN	APR'D:	DATE:	2012
	1	2023 UPDATE		DEC/23	TOWNSHIP OF SEVERN	DRAWN:	SCALE:	NTS
SEVERN					NOTES - SANITARY SEWERS	STD. No.	504	

#### WATER MAINS


- A. BEDDING AND COVER TO BE PER OPSD -802.010, GRANULAR 'A' EMBEDMENT MATERIAL OR OTHER APPROVED HOMOGENEOUS GRANULAR MATERIAL.
- B. TRENCH BACKFILL TO BE SELECT NATIVE MATERIAL AS APPROVED BY ENGINEER OR IMPORTED GRANULAR MATERIAL.
- C. SERVICE CONNECTIONS TO BE PER OPSD 1104.010 AND 1104.020, 100mm GRANULAR 'A' EMBEDMENT AND COVER OVER PIPE. TERMINATE AT PROPERTY LINE AT CENTRE OF LOT C/W CURB STOP AND BOX. TESTING TAIL TO SURFACE ATTACHED TO A 38mm x 89mm MARKER POST PAINTED BLUE.
- D. HYDRANTS TO BE PER OPSD 1105.010, DRAIN PLUGS SHALL BE INSTALLED.
- E. BACKFILL AND EMBEDMENT MATERIAL TO BE COMPACTED TO A DRY DENSITY OF AT LEAST 95% OF THE MATERIAL'S SPMDD,
- F. MINIMUM COVER ON WATER MAIN AND SERVICES TO BE 1.7 m.
- G. GATE VALVES, BENDS AND HYDRANT LEADS AND FITTINGS TO BE CONNECTED WITH ROMAC GRIP RING RESTRAINING CLAMP OR APPROVED EQUAL.
- H. CLEARANCE BETWEEN WATER MAINS AND SEWERS TO BE A MINIMUM OF 0.5m VERTICAL OR 3.0 m MINIMUM HORIZONTAL SEPARATION.
- I. SERVICES TO BE PER OPSD 1104.010.
- J. GENERAL INSTALLATION AND TESTING OF WATER MAIN AND APPURTENANCES TO BE IN ACCORDANCE WITH OPSS 441 ANSI/AWWA C651, MECP WATERMAIN DISINFECTION PROCEDURE AND ALL SPECIFICATIONS REFERENCED WITHIN THE CONTRACT DOCUMENTS.

	NO.	REVISION	APR'D	DATE	TOWNSHIP OF SEVERN	APR'D:	DATE:	2012
	1	2023 UPDATE		DEC/23	TOWNSHIP OF SEVERN	DRAWN:	SCALE:	NTS
Township of — SEVERN					NOTES - WATER MAINS	STD. No.	505	

#### **ROADS**

- A. SUBGRADE AND BOULEVARD MATERIAL TO BE COMPACTED TO A MINIMUM DRY DENSITY OF AT LEAST 95% OF THE MATERIAL'S SPMDD. SUBGRADE TO BE PROOF ROLLED AND CERTIFIED PRIOR TO PLACING GRANULAR 'B'.
- B. GRANULAR 'A' AND 'B' BASE TO BE COMPACTED TO 100% OF THE MATERIAL'S SPMDD.
- C. ROADWAYS TO BE CONSTRUCTED WITH MIN. 300mm GRANULAR 'B' TYPE 1, 150mm GRANULAR 'A', 50mm HL4 BASE AND 40mm HL3 SURFACE COURSE ASPHALT UNLESS OTHERWISE NOTED. ALL SUBDRAINS TO BE CONSTRUCTED IN ACCORDANCE WITH OPSS 405.
- D. SELECT SUBGRADE MATERIAL, OR IMPORTED GRANULAR MATERIAL APPROVED BY THE ENGINEER, COMPACTED TO 98% OF THE MATERIAL'S SPMDD, TO BE USED AS FILL IN ALL AREAS WHERE PROPOSED PIPE INVERTS ARE HIGHER THAN EXISTING GRADE OR AS INSTRUCTED BY THE ENGINEER.
- E. ALL GRANULARS AND ASPHALT MATERIALS AND PLACEMENT TO BE IN ACCORDANCE WITH OPSS 314 AND OPSS 310
- F. JOINTS WITH EXISTING ASPHALT TO BE SAW CUT STRAIGHT PRIOR TO PLACING NEW ASPHALT AND TACK COAT APPLIED TO EXISTING ASPHALT.
- G. STOP SIGNS AND STREET SIGNS TO TOWNSHIP STANDARDS.
- H. REINSTATEMENT OF ALL DISTURBED BOULEVARDS TO INCLUDE REGRADING, 150mm TOPSOIL AND SOD TO OPSS 802 AND 803.
- I. CONCRETE CURB AND GUTTER TO BE PER OPSD 600,040 AND OPSS 353
- J. CONCRETE SIDEWALK TO BE PER OPSD 310.010, 310.030 AND OPSS 351. SUBBASE TO CONSIST OF MINIMUM 150mm OF GRANULAR 'A'. TACTILE WALKING SURFACE INDICATORS TO BE PER OPSD 310.039.

	NO.	REVISION	APR'D	DATE	TOWNSLUD OF SEVERN	APR'D:	DATE:	2012
	1	2023 UPDATE		DEC/23	TOWNSHIP OF SEVERN	DRAWN:	SCALE:	NTS
— Township of —								
SEVERN					NOTES - ROADS	STD. No.	506	
2cacul					110.20 110/120	015.110.		

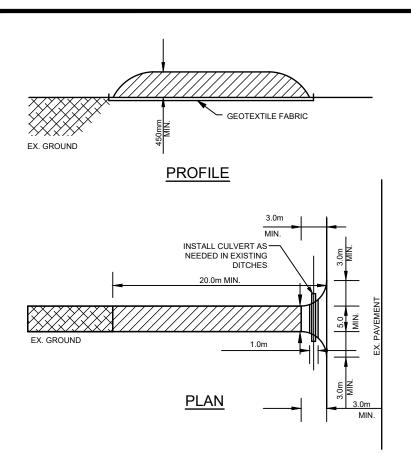


STONE SIZE - THE STONE PAD SHALL BE A MIN. 450mm THICK.

USE 50 TO 100mmØ STONE OR RECLAIMED CONCRETE EQUIVALENT FOR FIRST 15m FROM ADJACENT ROAD & 150mmØ STONE FOR REMAINDER OF STONE PAD.

- LENGTH AS REQUIRED BUT NOT LESS THAN 20m.
- WIDTH 5m MIN. BUT NOT LESS THAN THE WIDTH AT POINTS WHERE INGRESS AND EGRESS OCCURS.
- GEOTEXTILE FABRIC (TERRAFIX 270R OR EQUAL) WILL BE PLACED OVER THE ENTIRE AREA PRIOR TO PLACING STONE.
- SURFACE WATER ALL SURFACE WATER FLOWING OR DIRECTED TOWARD CONSTRUCTION ENTRANCES SHALL BE PIPED ACROSS THE ENTRANCE.
- MAINTENANCE THE CONTRACTOR SHALL MAINTAIN THE ENTRANCE IN A CONDITION WHICH WILL PREVENT TRACKING OR FLOWING OF SEDIMENT ONTO PUBLIC RIGHT-OF-WAY. THIS MAY REQUIRE PERIODIC DRESSING WITH ADDITIONAL STONE AS CONDITIONS DEMAND AND REPAIR AND/OR CLEANOUT OF ANY MEASURES USED TO TRAP SEDIMENT. ALL SEDIMENT SPILLED, DROPPED, WASHED OR TRACKED ONTO PUBLIC RIGHT-OF-WAY MUST BE REMOVED IMMEDIATELY BY THE CONTRACTOR. UPON OBSERVATION OF CONTINUOUS MUD TRACKING ONTO ADJACENT STREETS. THE STONE MAT IS TO BE FULLY REPLACED.
- WASHING WHEELS SHALL BE CLEANED TO REMOVE SEDIMENT PRIOR TO ENTRANCE ONTO PUBLIC RIGHT-OF-WAY. WHEN WASHING IS REQUIRED, IT SHALL BE DONE ON AN AREA STABILIZED WITH STONE AND WHICH DRAINS INTO AN APPROVED SEDIMENT TRAPPING DEVICE.
- INSPECTION AND REQUIRED MAINTENANCE AFTER EACH RAIN SHALL BE PROVIDED BY THE CONTRACTOR.

- ALL DIMENSIONS ARE IN METRES UNLESS OTHERWISE SPECIFIED.
- 2. PURPOSE OF CONSTRUCTION MAT IS TO MINIMIZE TRANSPORTATION OF SEDIMENT ONTO ROADWAYS.
- CONSTRUCTION MAT IS TO BE INSTALLED AS THE FIRST STEP IN THE SITE ALTERATION PROCESS.
- CONSTRUCTION MATS ARE REQUIRED WHERE PAVED ROADS ARE WITHIN 300m OF THE SITE.

I		NO.	REVISION	APR'D	DATE	TOWNSLUD OF SEVERN	APR'D:	DATE:	2012
ı		1	2023 UPDATE		DEC/23	TOWNSHIP OF SEVERN	DRAWN:	SCALE:	NTS
I	Township of —					CONSTRUCTION ENTRANCE MAT	STD. No.	601	
L	0-1-111								

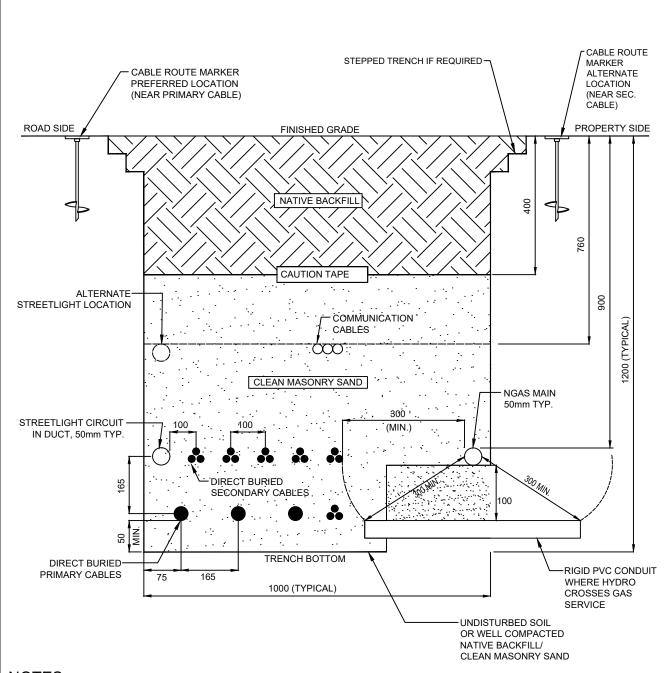


- ALL DIMENSIONS ARE IN MILLIMETRES UNLESS OTHERWISE SPECIFIED.
- BACKFILL TO CONSIST OF 150mm OF CLEAN MASON SAND ABOVE CABLES/DUCTS AND CLEAN NATIVE MATERIAL.
- 3. WARNING TAPE TO BE PLACED PRIOR TO PLACING THE FINAL 400mm OF BACKFILL.

NO.	REVISION	APR'D	DATE
1	2023 UPDATE	·	DEC/23

— Township of —
SEVERN

TOWNSHIP OF SEVERN	APR'D:	DATE:	2012
TOWNSHIP OF SEVERN	DRAWN:	SCALE:	NTS
JOINT UTILITY TRENCH - 4 PARTY	STD. No.	701	

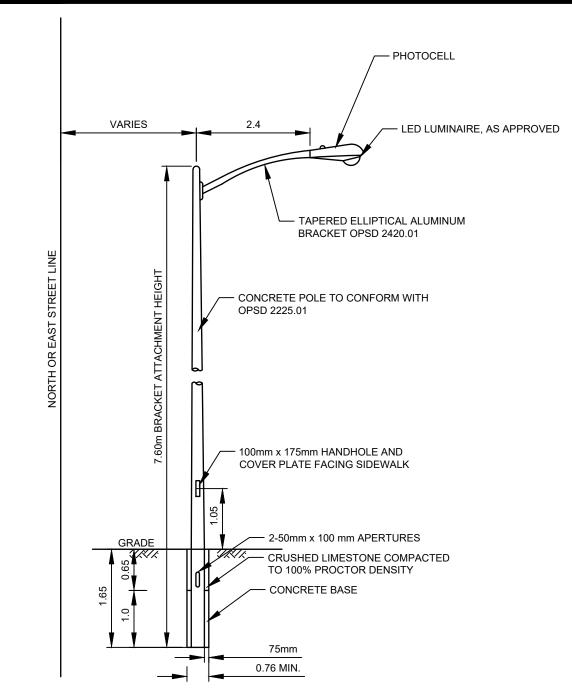


- ALL DIMENSIONS ARE IN METRES UNLESS OTHERWISE SPECIFIED.
- 2. S/L WIRING TO LOOP UP TO HANDHOLE CONNECTION TO LUMINAIRE WIRING BY MEANS OF ESNA FUSE AND CABLE CONNECTOR.
- 3. MINIMUM SIZE U/G CONDUCTOR AWG No 8.
- 4. DEPTH OF BURY TO BE MODIFIED TO SUIT POLE HEIGHT AS NECESSARY

NO.	REVISION	APR'D	DATE
1	2023 UPDATE		DEC/23

— Township of —
SEVERN


TOWNSHIP OF SEVERN	APR'D:	DATE:	2012
TOWNSHIP OF SEVERN	DRAWN:	SCALE: NTS	
STREET LIGHTING - DIRECT BURIED	STD. No.	702	

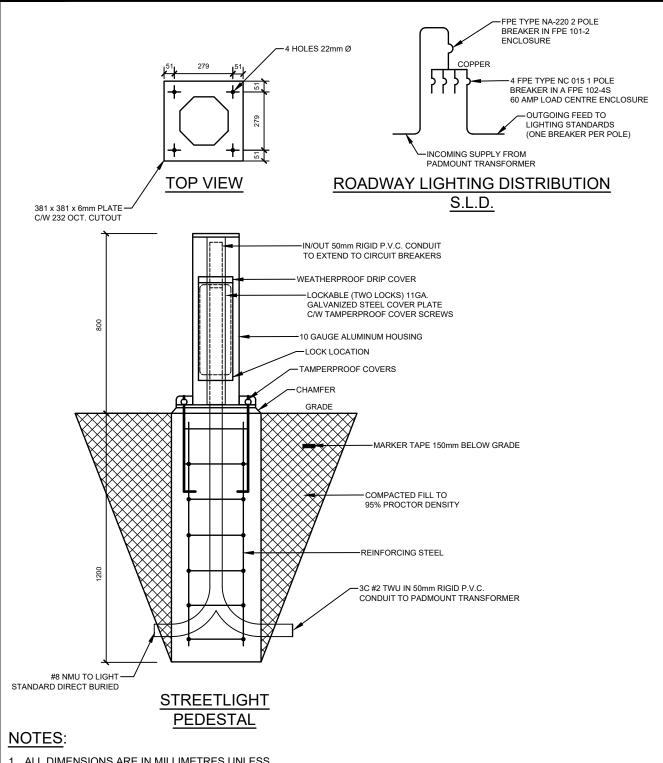


- 1. ALL DIMENSIONS ARE IN MILLIMETRES UNLESS OTHERWISE SPECIFIED.
- 2. SUPPLY & INSTALL GALVANIZED STEEL 800mm PEDESTAL ON CONCRETE BASE.
- 3. PEDESTAL SHALL HAVE BREAKERS.

NO.	REVISION	APR'D	DATE
1	2023 UPDATE		DEC/23

	TOWNSHIP OF SEVERN		DATE:	2012
			SCALE:	NTS
SEVERN	STREET LIGHT PEDESTAL	STD. No.	703	

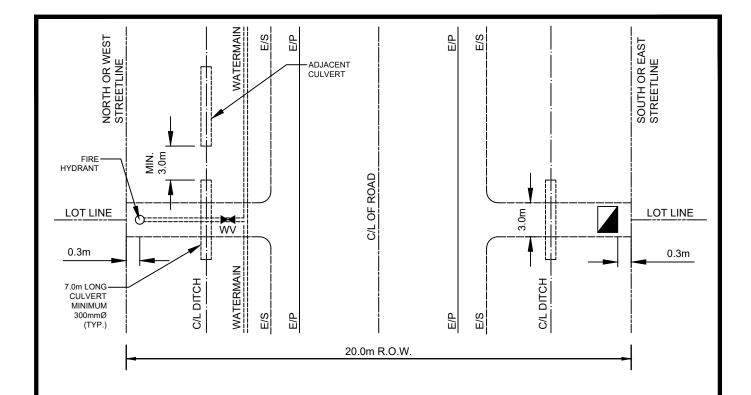


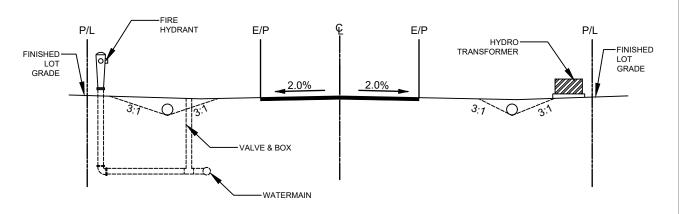

- 1. ALL DIMENSIONS ARE IN METRES UNLESS OTHERWISE SPECIFIED.
- THE CULVERT TO BE A MINIMUM LENGTH OF 7.0m TO PROVIDE A 3.0m PLATFORM TO ALLOW PEDESTRIAN TRAFFIC.
   THE PLATFORM AREA SHOULD NOT BE LARGE ENOUGH TO ACCOMMODATE VEHICULAR TRAFFIC.
- 3. THE DIAMETER OF THE CULVERTS WILL BE IN ACCORDANCE WITH THE STORM DRAINAGE PLAN.
- 4. MINIMUM 3.0m SEPARATION BETWEEN ACCESS CULVERT AND ADJACENT CULVERT.
- 5. TOP OF VALVE BOX TO BE FLUSH WITH ACCESS SURFACE.
- 6. THE VALVE STEM MAY REQUIRE AN EXTENSION TO ACCOMMODATE A STANDARD VALVE KEY.


NO.	REVISION	APR'D	DATE
1	2023 UPDATE & RENUMBERED		DEC/23

	TOWNSHIP OF SEVERN	APR'D:	DATE:	2012
TOWNSHIP OF SEVERIN		DRAWN:	SCALE:	NTS
SEVERN ACCESS CULVERTS FOR FIRE HYDRANTS AND HYDRO TRANSFORMERS	STD. No.	704		

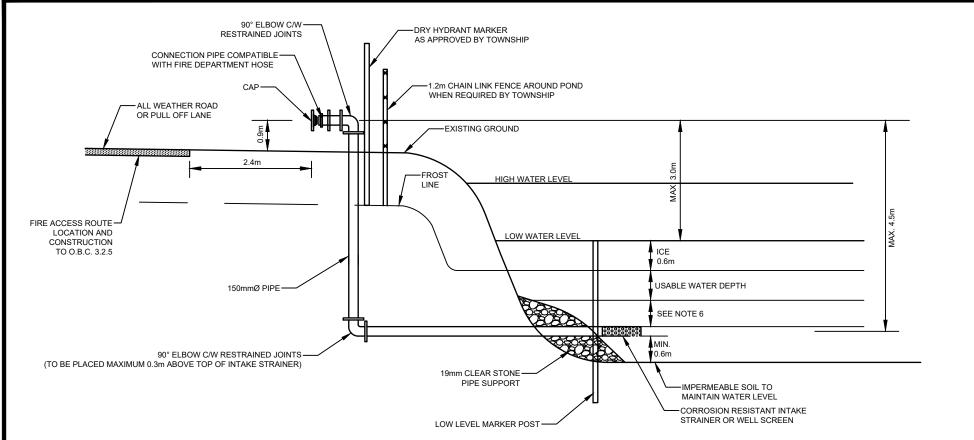

- 1. ALL DIMENSIONS ARE IN METRES UNLESS OTHERWISE SPECIFIED.
- 2. PIPE MATERIAL AND INSTALLATION TO CONFORM TO O.B.C. 7.2.11 AND NFPA 1142.
- 3. EFFECTIVE VOLUME OF POND WATER TO CONFORM TO O.B.C. APPENDIX A 3.2.57 (VOLUME = USABLE WATER DEPTH x POND AREA).
- 4. LOW WATER LEVEL TO BE STAKED AND MARKED. IF WATER LEVEL FALLS BELOW LOW WATER LEVEL, OWNER MUST REPLENISH WATER TO MAINTAIN MINIMUM WATER LEVEL.
- DRY HYDRANT TO BE TESTED AND BACK FLUSHED ANNUALLY WITH PUMPER TO VERIFY OPERATION.
- 6. WHEN POSSIBLE, A MINIMUM 0.6m WATER DEPTH IS RECOMMENDED BETWEEN OBVERT OF PIPE AND USABLE WATER DEPTH TO MINIMIZE VORTEX. WHERE POND DEPTH (LOW WATER LEVEL) WOULD EXCEED 2.4m, THIS AREA CAN BE INCLUDED IN USABLE WATER DEPTH CALCULATION TO MINIMIZE POND DEPTH.
- 7. IF GUIDE RAIL IS WARRANTED, PLACE WITHIN 1.5m OF THE CONNECTION FOR ACCESS.

	NO.	REVISION	APR'D	DATE	TOWNSHIP OF SEVERN	APR'D:	DATE:	2012
	1	2023 UPDATE & RENUMBERED		DEC/23	TOWNSHIP OF SEVERN	DRAWN:	SCALE:	NTS
Township of — SEVERN					DRY HYDRANT DETAIL	STD. No.	801	

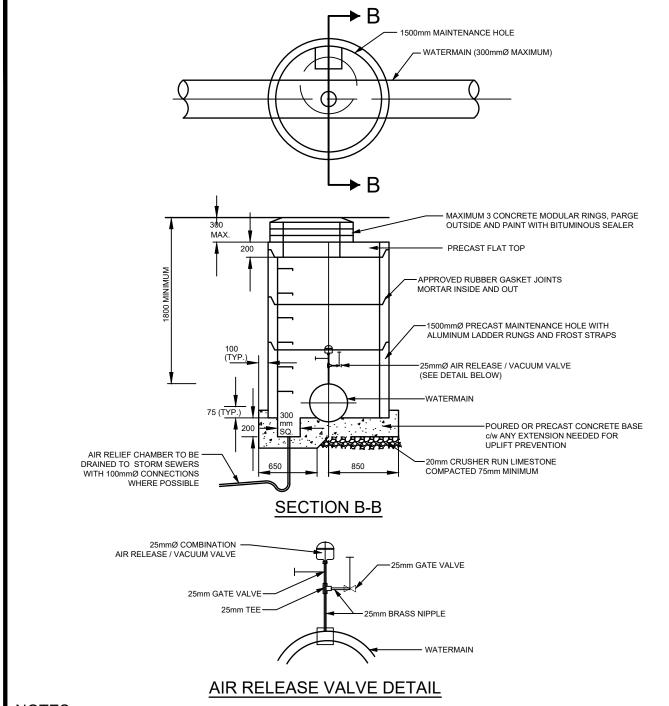


- ALL DIMENSIONS ARE IN MILLIMETRES UNLESS OTHERWISE SPECIFIED.
- 2. ALL FITTINGS TO BE BRASS.
- GRANULAR 'A' BACKFILL TO BE PLACED TO A MINIMUM THICKNESS OF 300mm ON ALL SIDES AND COMPACTED TO 100% STANDARD PROCTOR DENSITY.

NO.	REVISION	APR'D	DATE
1	2023 UPDATE & RENUMBERED		DEC/23

	1
SEVERN	All

TOWNSHIP OF SEVERN	APR'D:	DATE:	2012
TOWNSHIP OF SEVERN	DRAWN:	SCALE:	NTS
AIR RELEASE VALVE IN CHAMBER	STD. No.	802	

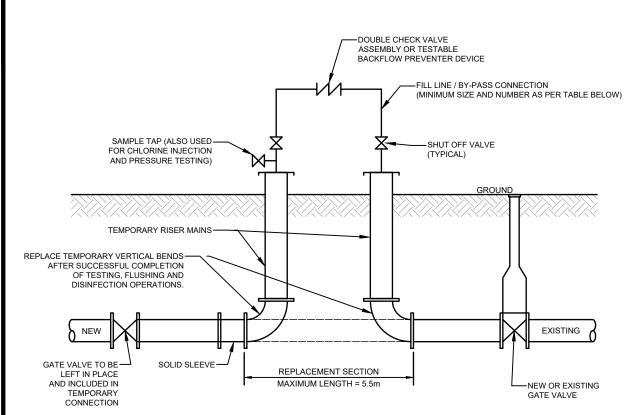

# TYPICAL TEMPORARY ABOVE GRADE BY-PASS CONNECTION FOR WATERMAINS


	FLOW REQUIRED	SIZE OF TAP (mm)  25 38 51			64mm
PIPE DIAMETER	TO PRODUCE 0.76m/S (APPROX.)				
	VELOCITY IN MAIN				HYDRANT OUTLETS
mm	l/s	NUMBER OF TAPS ON PIPE			
100	6.3	1		1	
150	12.6	-	1	-	1
200	25.2	-	2	1	1
250	37.9	-	2	2	1
300	56.8	3		2	
400	109.9	-	-	4	2

REQUIRED FLOW AND OPENINGS TO FLUSH PIPELINES (276kPa/40 PSI RESIDUAL PRESSURE IN WATERMAIN)

NO.	REVISION	APR'D	DATE
1	2023 UPDATE & RENUMBERED		DEC/23

— Township of —
SEVERN

TOWNSHIP OF SEVERN	APR'D:	DATE:	2012
TOWNSHIP OF SEVERN	DRAWN:	SCALE:	NTS
TEMPORARY ABOVE GRADE BY-PASS CONNECTION FOR WATERMAINS	STD. No.	803	

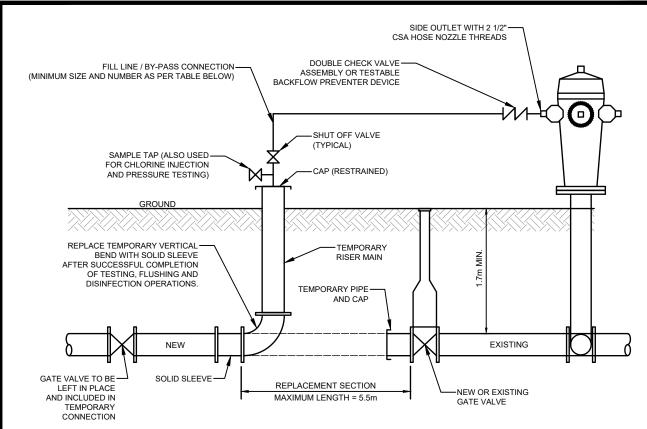

# TYPICAL TEMPORARY ABOVE GRADE BY-PASS CONNECTION TO EXISTING FIRE HYDRANT FOR NEW WATERMAINS


	FLOW REQUIRED TO PRODUCE 0.76m/S (APPROX.)	SIZE OF TAP (mm)			
PIPE DIAMETER		25	38	51	NUMBER OF OPEN 64mm
	VELOCITY IN MAIN				HYDRANT OUTLETS
mm	l/s	NUMBER OF TAPS ON PIPE			
100	6.3	1	-	1	1
150	12.6	-	1	-	1
200	25.2	-	2	1	1
250	37.9	-	2	2	1
300	56.8	-	-	3	2
400	109.9	-	-	4	2

REQUIRED FLOW AND OPENINGS TO FLUSH PIPELINES (276kPa/40 PSI RESIDUAL PRESSURE IN WATERMAIN)

NO.	REVISION	APR'D	DATE
1	2023 UPDATE & RENUMBERED		DEC/23

SEVERN	


TOWNSHIP OF SEVERN	APR'D:	DATE:	2012
IOWNSHIP OF SEVERIN	DRAWN:	SCALE:	NTS
TEMPORARY ABOVE GRADE BY-PASS CONNECTION TO EXISTING FIRE HYDRANT FOR NEW WATERMAINS	STD. No.	804	

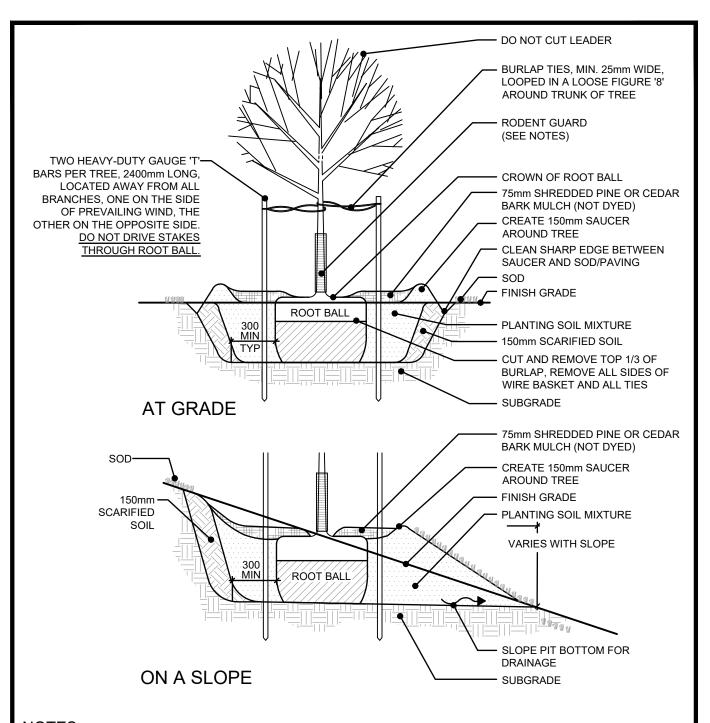

- 1. ALL DIMENSIONS ARE IN MILLIMETRES UNLESS OTHERWISE SPECIFIED.
- 2. DO NOT ALLOW AIR POCKETS WHEN BACKFILLING.
- 3. POSITION CROWN OF ROOT BALL 50mm ABOVE FINISH GRADE TO ALLOW FOR SETTLING.
- 4. DO CORRECTIVE PRUNING TO RETAIN NATURAL FORM OF TREE AS DIRECTED BY THE LANDSCAPE ARCHITECT.
- 5. FOR TREES PLANTED WITHIN PLANTING OR SHRUB BEDS, DELETE SAUCER AROUND BASE OF TREE.
- 6. NO TREE PITS SHALL BE LEFT OPEN OVERNIGHT.
- 7. RODENT GUARDS REQUIRED ONLY FOR TREES PLANTED IN NATURALIZED OR "NO-MOW" AREAS.

NO.	REVISION	APR'D	DATE
1	2023 UPDATE		DEC/23


	TOWNSHIP OF SEVERN	APR'D:	DATE:	2012
	TOWNSHIP OF SEVERN	DRAWN:	SCALE:	NTS
Township of — SEVERN	DECIDUOUS TREE PLANTING	STD. No.	1101	

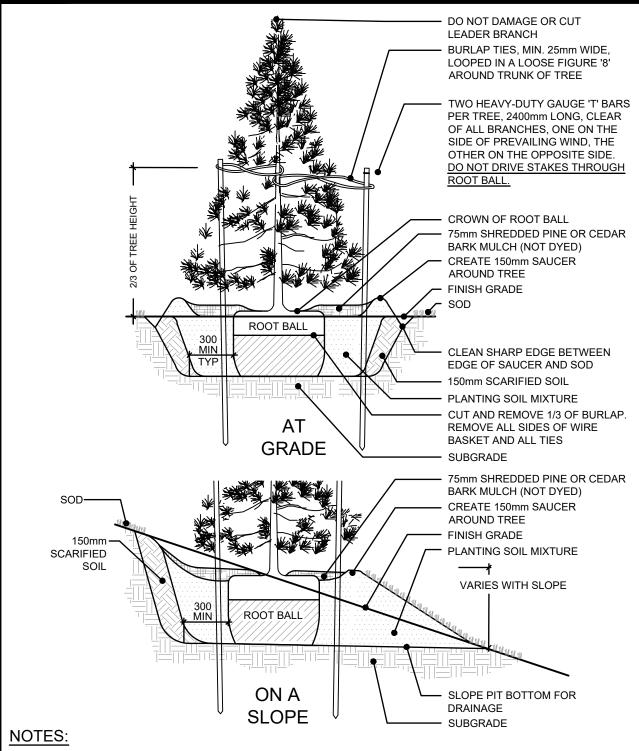


- 1. ALL DIMENSIONS IN MILLIMETRES UNLESS OTHERWISE SPECIFIED.
- 2. DO NOT ALLOW AIR POCKETS WHEN BACKFILLING.
- 3. POSITION CROWN OF ROOT BALL 50mm ABOVE FINISH GRADE TO ALLOW FOR SETTLING.
- 4. FOR TREES PLANTED WITHIN PLANTING OR SHRUB BEDS, DELETE SAUCER AROUND BASE OF TREE.
- 5. NO TREE PITS SHALL BE LEFT OPEN OVERNIGHT.

NO.	REVISION	APR'D	DATE
1	2023 UPDATE		DEC/23

	TOWNSHIP OF SEVERN	APR'D:	DATE:	2012
	TOWNSHIP OF SEVERIN	DRAWN:	SCALE:	NTS
Township of — SEVERN	CONIFEROUS TREE PLANTING	STD. No.	1102	2

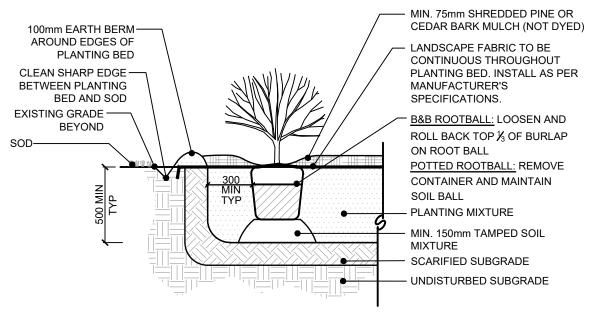

## TYPICAL SHRUB PLANTING

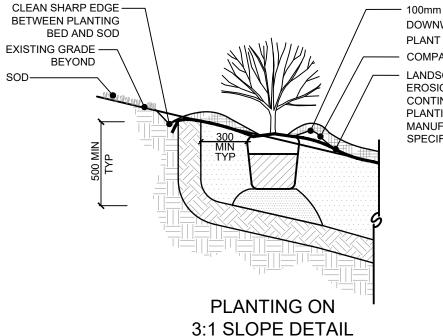


100mm EARTH BERM ON DOWNWARD SIDE OF ALL PLANT MATERIAL COMPACTED SLOPE

LANDSCAPE FABRIC AND/OR EROSION CONTROL MAT TO BE CONTINUOUS THROUGHOUT PLANTING BED. INSTALL AS PER MANUFACTURER'S SPECIFICATIONS

- ALL DIMENSIONS IN MILLIMETRES UNLESS OTHERWISE SPECIFIED.
- DO NOT ALLOW AIR POCKETS WHEN BACKFILLING.
- 3. POSITION CROWN OF ROOT BALL 25mm ABOVE FINISH GRADE TO ALLOW FOR SETTLING.

NO.	REVISION	APR'D	DATE
1	2023 UPDATE		DEC/23


	TOWNSHIP OF SEVERN	APR'D:	DATE:	2012
	TOWNSHIP OF SEVERN	DRAWN:	SCALE:	NTS
Township of —	SHRUB PLANTING	STD. No.	1103	3

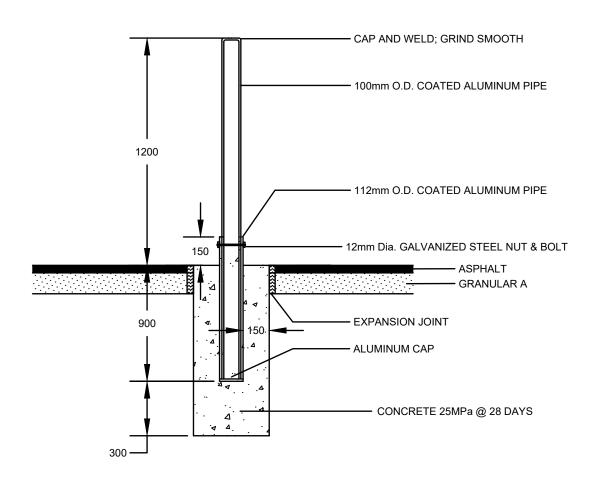

- ALL DIMENSIONS IN MILLIMETRES UNLESS OTHERWISE SPECIFIED.
- 2. POST TO BE CENTRED IN WALKWAYS.

NO.	REVISION	APR'D	DATE
1	2023 UPDATE		DEC/23

	TOWNSHIP OF SEVERN	APR'D:	DATE: 20	012
Township of — SEVERN	TOWNSHIP OF SEVERN	DRAWN:	SCALE: N	ITS
	REMOVABLE BOLLARD	STD. No.	1104	

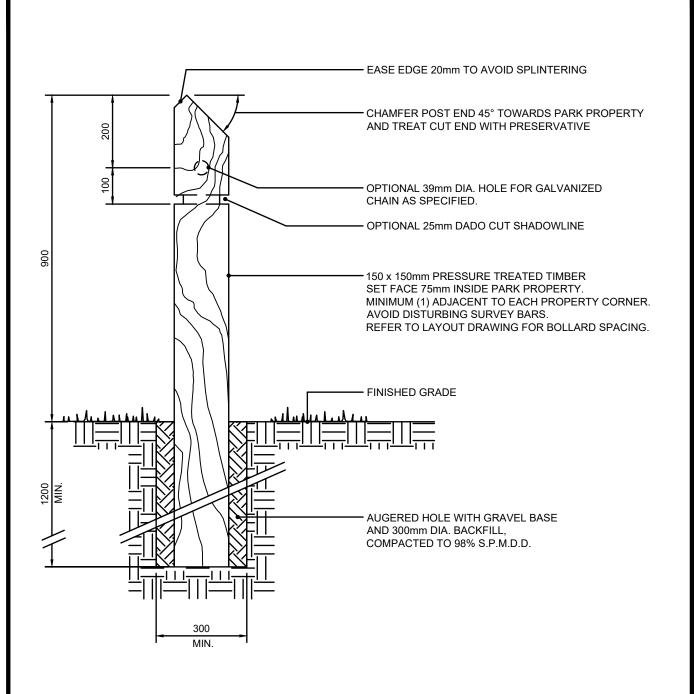

 ALL DIMENSIONS IN MILLIMETRES UNLESS OTHERWISE SPECIFIED.

NO.	REVISION	APR'D	DATE
1	2023 UPDATE		DEC/23

Township of — SEVERN	TOWNSHIP OF SEVERN	APR'D:	DATE: 2012
		DRAWN:	SCALE: NTS
	TIMBER BOLLARD	STD. No.	1105

